



Client: Hightown Housing Association

Daylight and Sunlight Assessment Provision for the Development at 29
Broadwater Road, Hertfordshire AL7 3BQ

October 2019

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1 Background and Scope of Appraisal

1.1 Study Objectives

Herrington Consulting has been commissioned by Hightown Housing Association to analyse and quantify the provision of natural daylight and sunlight to a selected number of habitable rooms within the proposed development. These are predominantly located on the internal faces of the courtyard and those on the north side of the building at 29 Broadwater Road, Hertfordshire AL7 3BQ.

1.2 Site Location

The site is situated town of Welwyn Garden City and is located within the County of Hertfordshire. The location of the site is shown in Figure 2.1 and the site plan included in Appendix A.1 of this report gives a more detailed reference to the site location and layout.

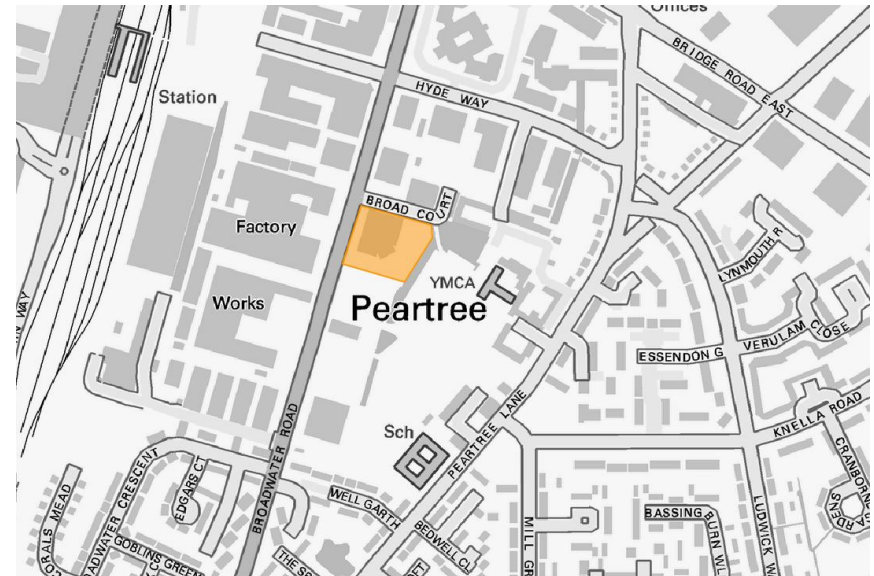


Figure 2.1 – Location map (Contains Ordnance Survey data © Crown copyright and database right 2011)

1.3 The Development

The proposal for development is to demolish the existing building and construct a 4-storey building containing residential units. Drawings of the proposed scheme are included in Appendix A.1 of this report.

2 Policy and Guidance

2.1 National Planning Policy

National Planning Policy Framework (Revised February 2019)

Paragraph 123 on 'Achieving appropriate densities' states that "(c) local planning authorities should refuse applications which they consider fail to make efficient use of land, taking into account the policies in this Framework. In this context, when considering applications for housing, authorities should take a flexible approach in applying policies or guidance relating to daylight and sunlight, where they would otherwise inhibit making efficient use of a site (as long as the resulting scheme would provide acceptable living standards)."

2.2 Regional Planning Policy

Hertfordshire County Council planning documents do not contain any information regarding daylight, sunlight or overshadowing.

2.3 Local Planning Policy

Welwyn Hatfield Supplementary Design Guidance (February 2005)

Paragraph 2.2 under 'Quality of Public Areas and the Public Realm' states that 'The main issues to be taken into account in the quality of public areas and the public realm are: that the design takes into account the micro climate (i.e. the daylight and sunlight, the wind, the temperature and frost pockets), as this will

influence both the orientation and design of buildings and the degree of enclosure'.

Paragraph 3.3 under 'Passive Solar Design (PSD)' states that 'This is the design of buildings to make the most of energy available freely from the sun in the form of solar heat, daylight and wind, so minimising the need for artificial means of heating, lighting, ventilation and cooling'. Further to this, paragraph 3.3 states that 'The key principles of passive solar design are:...Providing adequate access to daylight'.

Paragraph 3.9 under 'Built Form and PSD' states that 'The form of a building can affect PSD. A building with large or poorly positioned wings, eaves or overly wide eaves, may overshadow itself, reduce solar gain and daylighting. However, well-proportioned eaves can provide welcome shade in the summer...'. Further to this, paragraph 3.10 states that 'Buildings with a deep floor plan, whilst having a smaller external envelope are only able to achieve natural daylight close to the windows and natural ventilation can be difficult to achieve. One way of overcoming this is to incorporate a central atrium into the development to bring in daylight, natural ventilation and improve amenity'.

Paragraph 3.18 under 'Sunlight and Daylight' states that 'This section supplements Policy D1 Quality of Design in the District Plan. All new developments should be designed and built to ensure that there is a satisfactory level of sunlight and daylight to both the new development and surrounding developments and/or open spaces... Access to sunlight and daylight not only improves the interior and exterior appearance of a building, it also improves the

standard of living or workspace for the residents or users of a building. Access to sunlight can help make a building more energy efficient, whilst daylight reduces the need for electric lighting and winter solar gain can meet some of the heating requirements. Advice on site layout planning to achieve good sunlight and daylight within the buildings and the open spaces between them is set out in the Building Research Establishment's document entitled, 'Site Layout Planning for Daylight and Sunlight: a guide to good practice', 1991'.

2.4 Best Practice Guidance

In the absence of official national planning guidance / legislation on daylight and sunlight, the most recognised guidance document is published by the Building Research Establishment and entitled 'Site Layout Planning for Daylight and Sunlight – A Guide to Good Practice', Second Edition, 2011; herein referred to as the 'BRE Guidelines'.

The BRE Guidelines are not mandatory and themselves state that they should not be used as an instrument of planning policy, however in practice they are heavily relied upon as they provide a good guide to approach, methodology and evaluation of daylight and sunlight impacts.

In conjunction with the BRE Guidelines further guidance is given within the British Standard (BS) 8206-2:2008: 'Lighting for buildings - Part 2: Code of practice for daylighting'.

In this assessment, the BRE Guidelines have been used to establish the extent to which the Proposed Development meets current best practice guidelines. In

cases where the Development is likely to reduce light to key windows the study has compared results against the BRE criteria.

Whilst the BRE Guidelines provide numerical guidance for daylight, sunlight and overshadowing, these criteria should not be seen as absolute targets. The document states that the intention of the guide is to aid rather than constrain the designer. The Guide is not an instrument of planning policy, therefore whilst the methods given are technically robust, it is acknowledged that some level of flexibility should be applied where appropriate.

3 Assessment Techniques

3.1 Background

Natural light refers to both daylight and sunlight. However, a distinction between these two concepts is required for the purpose of analysis and quantification of natural light in buildings. In this assessment, the term '*Daylight*' is used for natural light where the source is the sky in overcast conditions, whilst '*Sunlight*' refers specifically to the light coming directly from the sun.

3.2 Average Daylight Factor

The Average Daylight Factor (ADF) method calculates the average illuminance within a room as a proportion of the illuminance available to an unobstructed point outdoors under a sky of known luminance and luminance distribution. This is the most detailed of the daylight calculations and considers the physical nature of the room behind the window, including; window transmittance, and surface reflectivity.

This method of quantifying the availability of daylight within a room does, however, require the internal layout to be known and is generally only used for establishing daylight provision in new rooms. The BRE Guide sets out the following guidelines for the assessment of the ADF:

If a predominantly daylit appearance is required, then the ADF should be 5% or more if there is no supplementary electric lighting, or 2% or more if

supplementary electric lighting is provided. In dwellings, the following minimum average daylight factors should be achieved: 1% in bedrooms, 1.5% in living rooms and 2% in kitchens.

3.3 No Sky Line

The No Sky Line, or sometimes referred to as No Sky View method, describes the distribution of daylight within rooms by calculating the area of the 'working plane', which can receive a direct view of the sky. The working plane height is generally set at 850mm above floor level within a residential property and 700mm within a commercial property.

If a significant area of the working plane lies beyond the NSL, i.e. this area of the room has no view of the sky at the working plane height, there is likely to be a poor distribution of daylight within the room. However, this test is relatively simplistic and based purely on geometric parameters. Consequently, no account is taken of the reflectance of light within the room.

The BRE Guidelines do recommend that the NSL test is applied alongside the ADF test, and this is primarily to provide an indication of how well the daylight within the room is distributed. The determination of the level of adequacy of natural daylighting is, however, still predominantly driven by the ADF target values. Notwithstanding this, the NSL test does provide useful information on the way that the daylight is distributed within a room and this is often useful to the designer. The NSL test has therefore been undertaken alongside the ADF analysis and the graphical and numerical outputs are included within the

appendix to this report. These results are, however, only used in a qualitative and informative way, rather than a quantitative pass/fail manner.

3.4 Room Depth Criteria

The BRE Guidelines do include advice for determining recommended room depths to proposed new rooms under specific circumstances using the Room Depth Criteria (RDC). This is more of a rule-of-thumb test that can be used to plan building layouts etc at an early conceptual stage, rather than providing quantitative outputs at the more detailed stage of a development.

This test has numerous limitations when being applied to anything but a simplistic room layout and does not take into account external obstructions. It is therefore not considered to provide any meaningful data on the level or distribution of daylight that is not already provided by the ADF and NSL tests. Consequently, it is only applied in very particular situations.

3.5 Annual Probable Sunlight Hours

It is also possible to quantify the amount of sunlight available to a new development and the recognised methodology for undertaking this analysis is the Annual Probable Sunlight Hours (APSH) method.

For a typical development to be considered as having very good levels of direct sunlight, the centre point of the window would ideally need to receive more than 25% of APSH for the year, including at least 5% in the winter months between 21st September and the 21st March. The BRE Guidelines also recommend having at least one main window of the proposed development facing within 90

degrees of due south, with priority given to living rooms where sunlight is especially appreciated in the afternoon. Bedrooms and kitchens are generally viewed as less important, where occupants normally prefer sunlight in the mornings.

For new development and especially where existing buildings are being re-developed, it is important to acknowledge that these are aspirational targets intended to aid and not constrain the designer.

3.6 Overshadowing

The BRE Guidance suggests that where new development is served by amenity areas, then analysis can be undertaken to quantify the amount of sunlight these amenity areas will enjoy. Typical examples of areas that could be considered as open spaces or amenity areas are main back gardens of houses, allotments, parks and playing fields, children's playgrounds, outdoor swimming pools, sitting-out areas, such as in public squares and focal points for views, such as a group of monuments or fountains.

Sun Hours on Ground

The BRE Guidelines recommend that for a garden or amenity area to appear adequately sunlit throughout the year, at least 50% of an amenity area should receive at least 2 hours of sunlight on 21st March.

When undertaking this analysis, sunlight from an altitude of 10° or less has been ignored as this is likely to be obscured by planting and undulations in the surrounding topography. Driveways and hard standing for cars is also usually left

out of the area used for this calculation. Fences or walls less than 1.5 metres high are also ignored. Front gardens which are relatively small and visible from public footpaths are omitted with only main back gardens needing to be analysed.

The Guidelines also state that “normally, trees and shrubs need not be included, partly because their shapes are almost impossible to predict, and partly because the dappled shade of a tree is more pleasant than a deep shadow of a building”. This is especially the case for deciduous trees, which provide welcome shade in the summer whilst allowing sunlight to penetrate during the winter months.

4 Assessment Methodology

4.1 Method of Baseline Data Collation

The following data and information has been used to inform this study:

- OS Mastermap mapping
- Measured survey data (Norman Stangroome Associates – September 2018)
- Scheme drawings in AutoCAD format (McBains Ltd – April 2019)
- Aerial photography (Google Maps and Bing)

4.2 Numerical Modelling

The numerical analysis used in this assessment has been undertaken using the Waldrum Tools (Version 4.1.0.5) software package.

4.3 Calculation Assumptions

The following assumptions have been made when undertaking the analysis:

- When assessing the ADF for internal rooms and in the absence of specific information, the following parameters are assumed:
 - The glazing type is assumed to be double glazing (Pilkington K Glass 4/16/4 Argon filled) with a light transmittance value of 0.78 (value for double glazed unit not per pane).
 - Correction factor for frames and glazing bars = 0.8
 - Where information from the designer is not available, the following values are used to derive the Maintenance Factor applied to the transmittance values.

Location / setting	Building type (Residential – good maintenance)	Exposure (normal)	Special exposure	Maintenance Factor
Urban	8%	x 1.0	x 1.0	0.92
Rural / suburban	4%	x 1.0	x 1.0	0.96

Table 4.1 – Parameters used for deriving Maintenance Factor (refer to BS 8206-2:2008 Tables A3, A4 and A5)

- The reflectance values used in the ADF analysis of the proposed new buildings are shown in table 4.2 below and are used unless specified otherwise by the designer:

Surface	Value
Internal walls (painted pale cream)	81%
Internal ceiling (painted white)	85%
Internal flooring	30%

Table 4.2 – Reflectance values used in ADF analysis

5 Daylight Provision to Proposed New Rooms

5.1 Overview

As discussed in Section 4, the primary test for daylight is the Average Daylight Factor (ADF) test and this is discussed in detail in the following section. The No Sky Line (NSL) analysis has also been carried out to provide supporting information on the distribution of daylight within each of the habitable rooms. The NSL results are processed by the computational model in both graphical and numerical formats and these are included in the appendix to this report.

5.2 Average Daylight Factor

Using the analytical techniques and assumptions discussed in Sections 3 and 4, the daylighting tests have been applied for the habitable rooms within the proposed development.

In accordance with the guidance set out in both the BRE Guidelines and the BS 8206-2:2008 document, rooms that have a dual use, i.e. an open plan kitchen and lounge, are assessed as a single room and assessed against the room use with the highest daylighting requirement. For example, where a room includes both living and kitchen spaces, then the higher daylighting requirement of the kitchen is adopted as the threshold target.

However, where kitchens have a floor area that is less than 13m² then it is conventional to assume that this is not a habitable room and the daylight tests

need not be applied. Notwithstanding this, where kitchens form an integral part of a room, they have been included but the interpretation of the daylighting results reflects the non-habitable status of the kitchen area.

The results of this analysis are included in Appendix A.3 of this report and this shows the calculated ADF values for each room within the 79 flats tested.

From the results it can be seen that the majority of rooms within the proposed development exceed the minimum required ADF target values prescribed by the BRE Guidelines.

There are, however, 6 rooms which are falling short of the target ADF values recommended by the BRE Guidelines. As discussed previously, the aspirational ADF level for a room with mixed use is that with the higher ADF target value. In this case, all rooms which are falling below the target value are LKDs and therefore when taking the higher use (of the kitchen) as the target value, this would be 2.0%. However, further inspection of the floor plans show that the constraints regarding the density of development at this site have influenced the design such that some of the apartments contain kitchens to the side of a larger room only. These kitchens are not considered to be habitable rooms in their own right due to the small room area assigned to the kitchen as part of the multi-use room.

In situations such as this, it is normal practice to assess the daylighting values for the 'dominant' room use, which in this case would be taken as the living space.

A more realistic target ADF value would therefore be taken as 1.5% rather than 2.0%.

This approach is supported by the BRE Guidelines, which advise that this is acceptable so long as the kitchen area is directly linked to a well-lit space. This is the case for all 6 remaining rooms, and therefore working towards a reduced target ADF value is considered acceptable. Given that all rooms exceed 1.5%, it can therefore be concluded that all rooms receive a good level of natural daylight that is commensurate with the predominant room use.

6 Sunlight Provision to Proposed Development

6.1 Annual Probable Sunlight Hours Assessment

The BRE Guidelines provide guidance in respect of sunlight quality for new developments stating: “in housing, the main requirement for sunlight is in living rooms, where it is valued at any time of the day, but especially in the afternoon. Sunlight is also required in conservatories. It is viewed as less important in bedrooms and in kitchens where people prefer it in the morning rather than the afternoon.”

The assessment criteria set out within the BRE document are discussed in Section 4.3 of this report, but in general terms the overall objective sought by the guidelines is as follows: *“In general, a dwelling or non-domestic building which has a particular requirement for sunlight, will appear reasonably sunlit provided that at least one main window faces within 90 degrees of due south; and the centre of at least one window to a main living room can receive 25% of annual probable sunlight hours, including at least 5% of annual probable sunlight hours in the winter months between 21st September and 21st March”.*

It is also worth noting that in paragraph 3.1.11 of the BRE guidance it is suggested that if a room faces significantly north of due east or west it is unlikely to meet the recommended levels of sunlight. A further observation from paragraph 5.3 of the BS 8206-2 is that with regards to sunlight duration, the degree of satisfaction is related to the expectation of sunlight. Therefore, if a room

is north facing or if the building is in a densely-built urban area, the absence of sunlight is more acceptable than when its exclusion seems arbitrary.

It should be noted that where rooms have more than one window, it is acceptable to sum the non-coincident sunlight hours to achieve a ‘room total’. This approach is acknowledged by the BRE Guidelines and facilitates a greater understanding of the sunlight received within a room by taking into account the fact that some windows will receive sunlight at different times during the day.

The complete set of results of the APSH analysis are presented in Appendix A.3 of this report.

The results in Appendix A.3 show that for the majority of flats there is a living area which receives sunlight levels above the BRE recommendations of 25% Annual Probable Sunlight hours and 5% Winter Probable Sunlight Hours.

This leaves 10 flats which contain living areas which are not reaching these aspirational target values. For 6 of these flats (Flats 24, 30, 44, 50, 64 & 70) this is due to the windows facing within 90degrees of due north.

An observation from Paragraph 5.3 of the BS 8206-2 on this point is that with regards to sunlight duration, the degree of satisfaction is related to the expectation of sunlight. Therefore, if a room is north facing, then the expectation of sunlight by occupants will be lower.

It is also worth acknowledging at this point that the BRE target levels for sunlight are based on typical dwelling configuration and are not necessarily entirely appropriate for more dense apartment style development. In such cases, it is widely acknowledged that not all units will have south facing aspects.

When examining the results of the 4 remaining flats (Flats 11, 31, 51 and 53), it is clear that in addition to the main living space that has been reported on, with the exception of Flat 11, all flats contains another habitable room which receives in excess of the recommended target sunlight levels. Inspection of the results for Flat 11 show that this unit is only very marginally below the aspirational target values. Therefore, given that the vast majority of the rooms within the proposed development meet or exceed the target sunlight levels, the development as a whole is considered to offer a high level of amenity value that is derived directly from sunlight.

It is important to note that the NPPF states that *“when considering applications for housing, authorities should take a flexible approach in applying policies or guidance relating to daylight and sunlight, where they would otherwise inhibit making efficient use of a site”*. Further to this, the Welwyn Hatfield Supplementary Design Guidance (February 2005) states that *“All new development should be designed and built to ensure that there is a satisfactory level of sunlight and daylight”*.

Taking into account the high level of compliance with BRE sunlight targets and the recommendations of the NPPF for authorities to take a flexible approach when applying daylight and sunlight guidelines, the overall sunlight levels are

considered to represent a respectable achievement for a development of this scale and would be considered to be satisfactory.

6.2 Direct Sunlighting to Amenity Spaces

The BRE Guidelines acknowledge that good site layout planning for daylight and sunlight should not limit itself to providing good natural light inside buildings. Sunlight in the space between buildings has an important effect on the overall appearance and ambiance of a development. The worst situation is to have significant areas on which the sun does not shine for a large part of the year. These areas would, in general, be damp, chilly and uninviting.

The BRE Guidelines set out the following principle benefits of sunlight in the spaces between buildings:

- To provide attractive sunlit views (all year)
- To make outdoor activities, like sitting out and children’s play more pleasant (mainly during the warmer months)
- To encourage plant growth (mainly in spring and summer)
- To dry out the ground, reducing moss and slime (mainly during the colder months)
- To melt frost, ice and snow (in winter)
- To dry clothes (all year)

The assessment criteria set out within the BRE Guidelines is based on the recommendation that for an amenity space to appear adequately sunlit

throughout the year, at least half of this area should receive at least two hours of sunlight on 21st March.

Inspection of the site plan shows clearly that the residents of the apartments will have access to a large area of amenity space in the centre of the courtyard which is accessible to all. The analysis that has been undertaken as part of this assessment (refer to appendix for detailed graphical and numerical outputs) has demonstrated that this area will receive well in excess of 2 hours of direct sunlight to all of its area on the 21st March. In exceeding the minimum target of 50%, this amenity space will deliver the principle benefits derived from direct sunlight and as a result will help deliver the amenity benefits provided by outdoor spaces.

7 Conclusions

The detailed analysis undertaken as part of this assessment has examined the provision of natural daylight and sunlight to the habitable rooms for the proposed development at 29 Broadwater Road, Hertfordshire. Using detailed numerical modelling applications, the Average Daylight Factor (ADF) and Annual Probable Sunlight Hours (APSH) have been quantified for each room. In line with the assessment criteria prescribed by the BRE Guidelines, it has been shown that for all rooms, the provision of natural daylight will meet or exceed the minimum required threshold set out in both the BRE Guidelines. Consequently, it can be concluded that these habitable spaces will be well lit and will have a reduced reliance on supplementary electric lighting.

Taking into account the factors explored in Section 6, it has also been possible to demonstrate that in the habitable rooms of the proposed development, the LKD and bedroom areas tested will receive satisfactory levels of sunlight throughout the year. There are a number of units that are north facing and as such fall short of the aspirational sunlight targets. However, it is widely acknowledged that for a development of this scale and nature, design constraints prohibit the ability to completely avoid north-facing single aspect units. When considering the results of the daylight analysis for the small number of rooms falling short of the recommended APSH values, it can be seen that they all surpass the ADF daylighting criteria. Consequently, whilst these rooms may not

receive high levels of direct sunlight, they will be well lit by natural daylight. The fact that there is only a limited amount of direct sunlight to these rooms does not, in this case, significantly detract from the amenity value of the rooms and consequently, it can be demonstrated that the proposed rooms tested will achieve acceptable living standards.

Furthermore, the assessment of the sunlight available to proposed amenity area indicates that this large amenity space will receive direct sunlight to the whole area for at least 2 hours a day.


A Appendices

Appendix A.1 – Scheme Drawings

Appendix A.2 – Graphical Model Outputs

Appendix A.3 – Tabulated Results for Daylight & Sunlight Calculations (Provision to New Development)

Appendix A.1 – Scheme Drawings

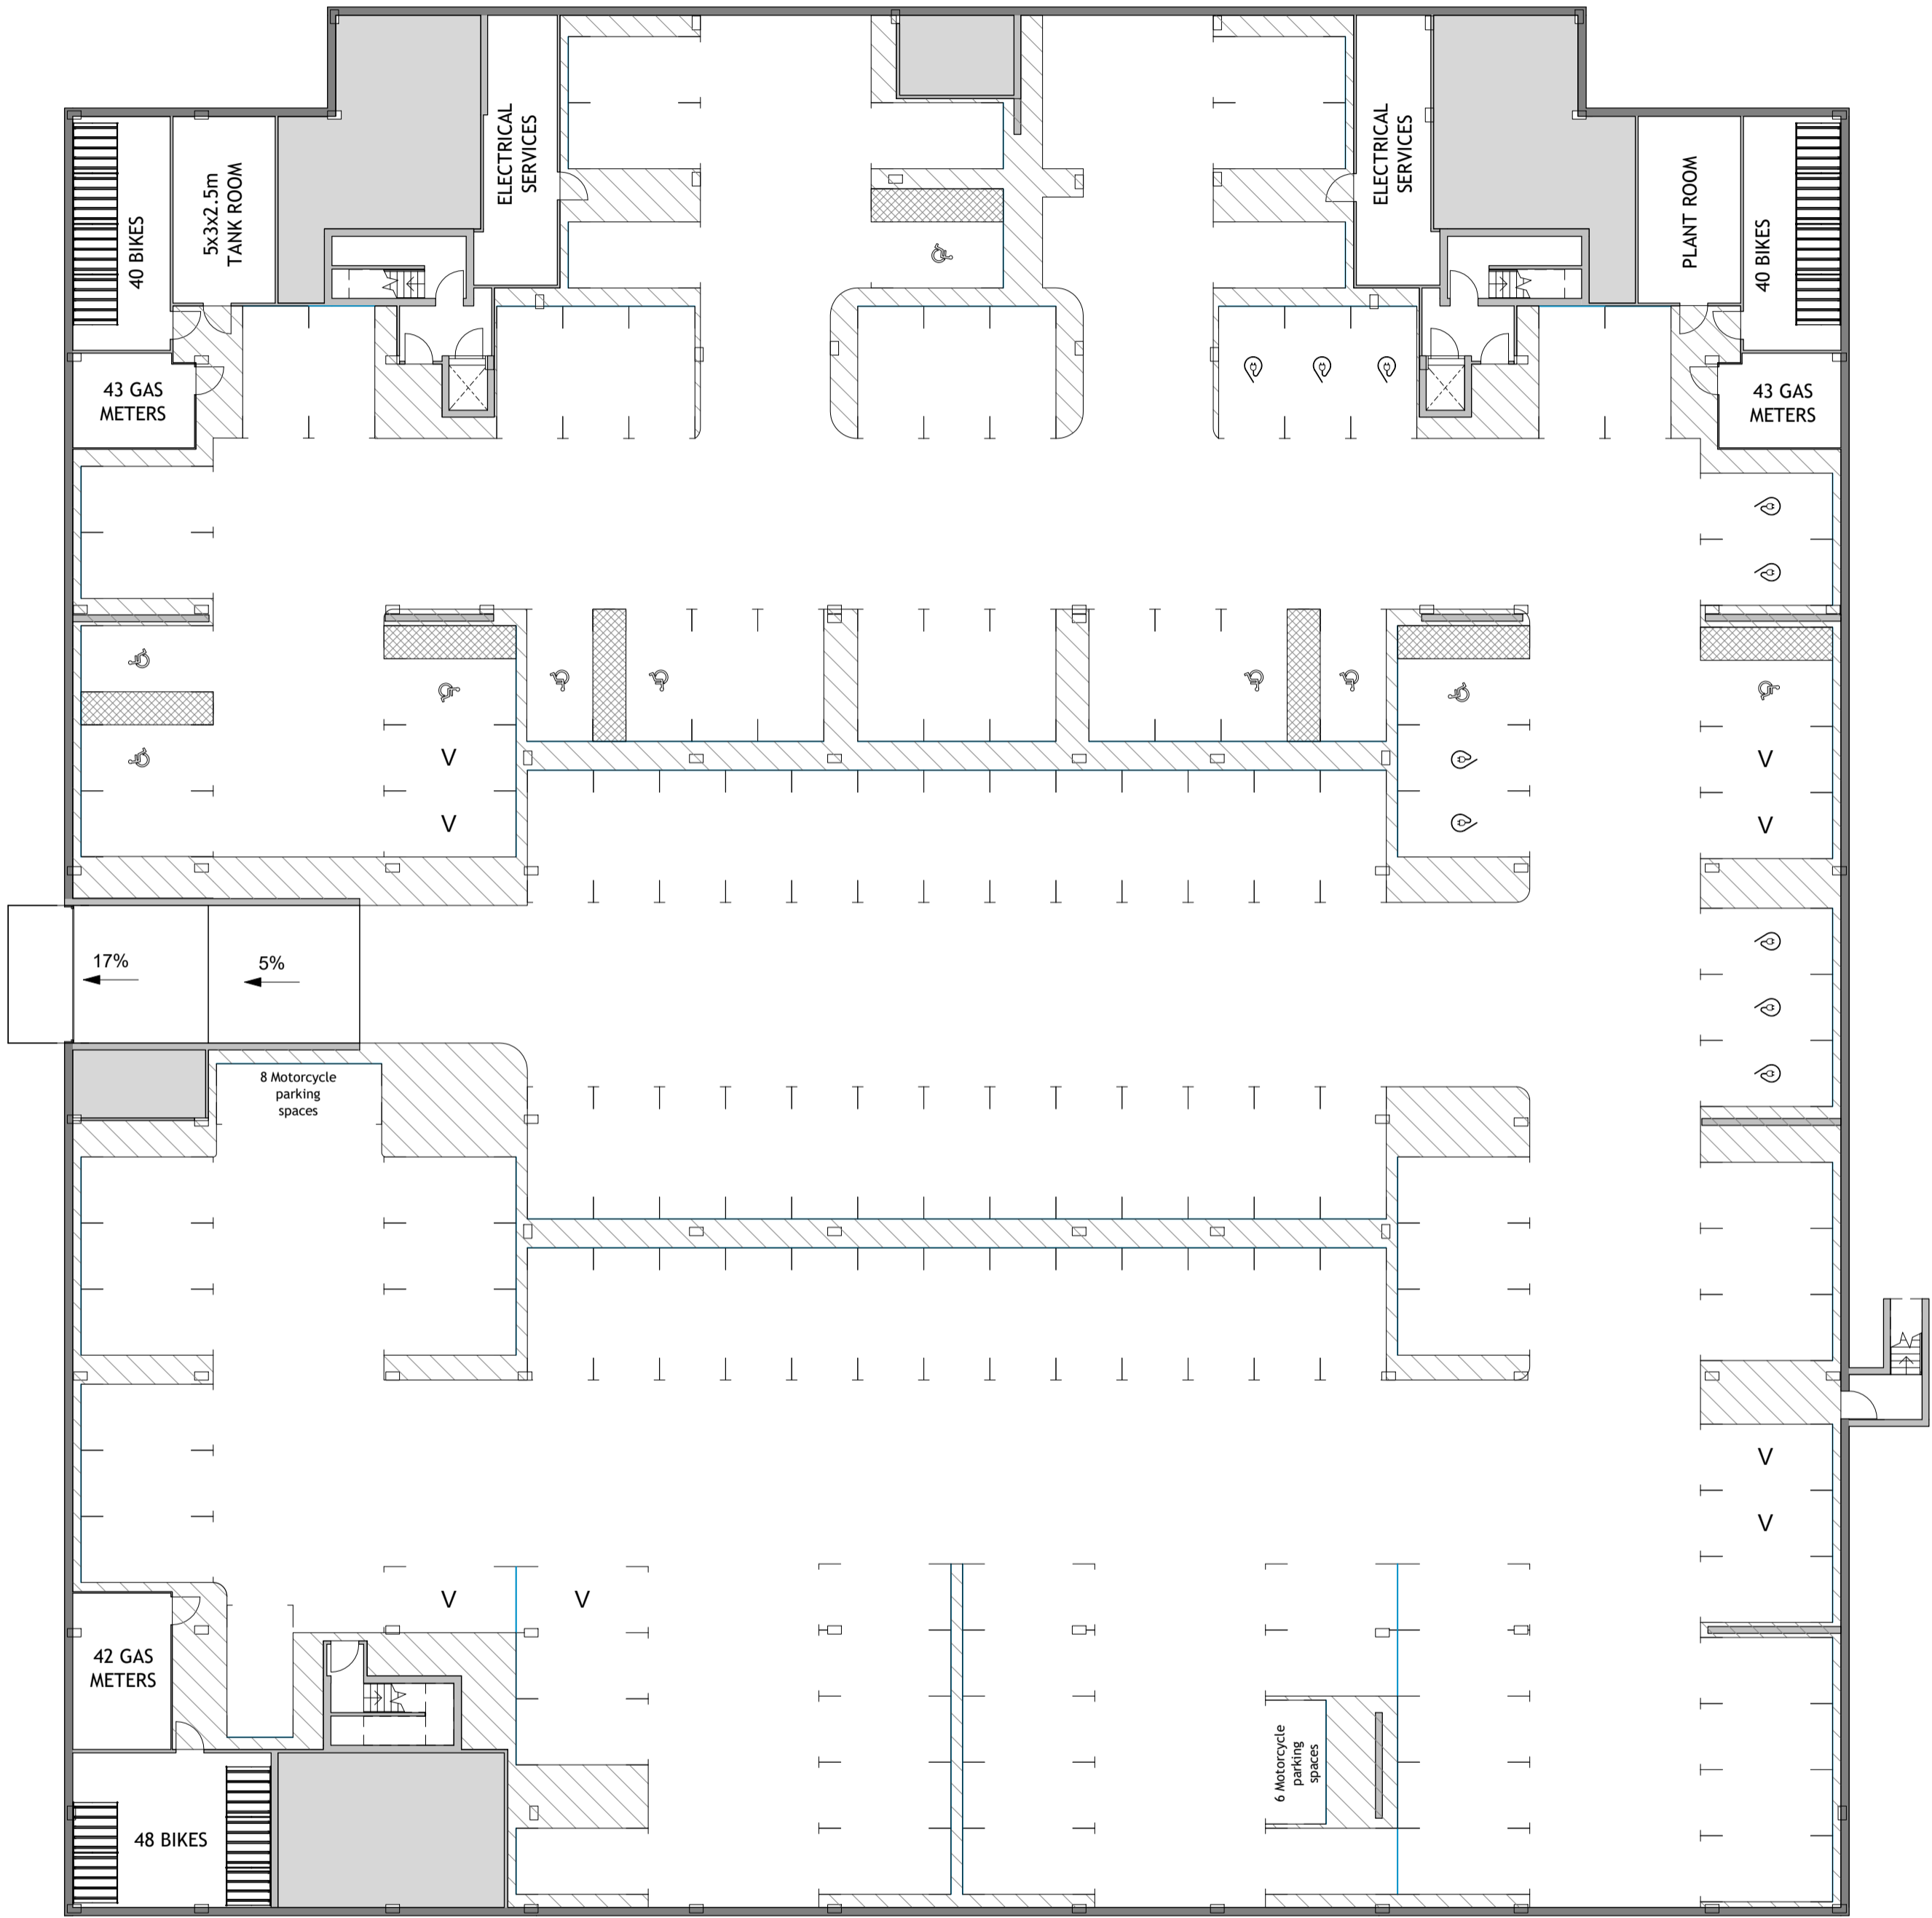

- BASEMENT PLAN KEY**
- DISEABLE PARKING SPACE
 - ELECTRIC CAR CHARGING POINT
 - VISITORS PARKING SPACE

- 136 CAR PARKING SPACES**
- 126 STANDARD PARKING SPACES 2.4m x 4.8m
 - 10 DISEABLE PARKING SPACES 3.0m x 4.8m

- 14 MOTORCYCLE PARKING SPACES**

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Basement Floor Plan
1 : 200

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Ground Floor Plan
1 : 200

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Drawing Title
Ground Floor Plan

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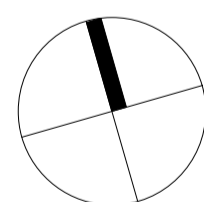
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Drawing Title	Third Floor Plan
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ARCHITECTURE

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North Elevation
1 : 100

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P1.1

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Drawing / Document Reference							Status	
BRW01 - MCB - ZZ - ZZ - DR - A - 0501							SZ - P1.2	
Project Idm	Originator	Zone	Level	Type	Discipline	Number	Suitability	Revision




East Elevation
1 : 100



East Elevation - Patio
1 : 100

Notes
Contractors must verify all dimensions on site before commencing any work on shop drawings Do not scale from this drawing
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South Elevation
1 : 100

DRAFT

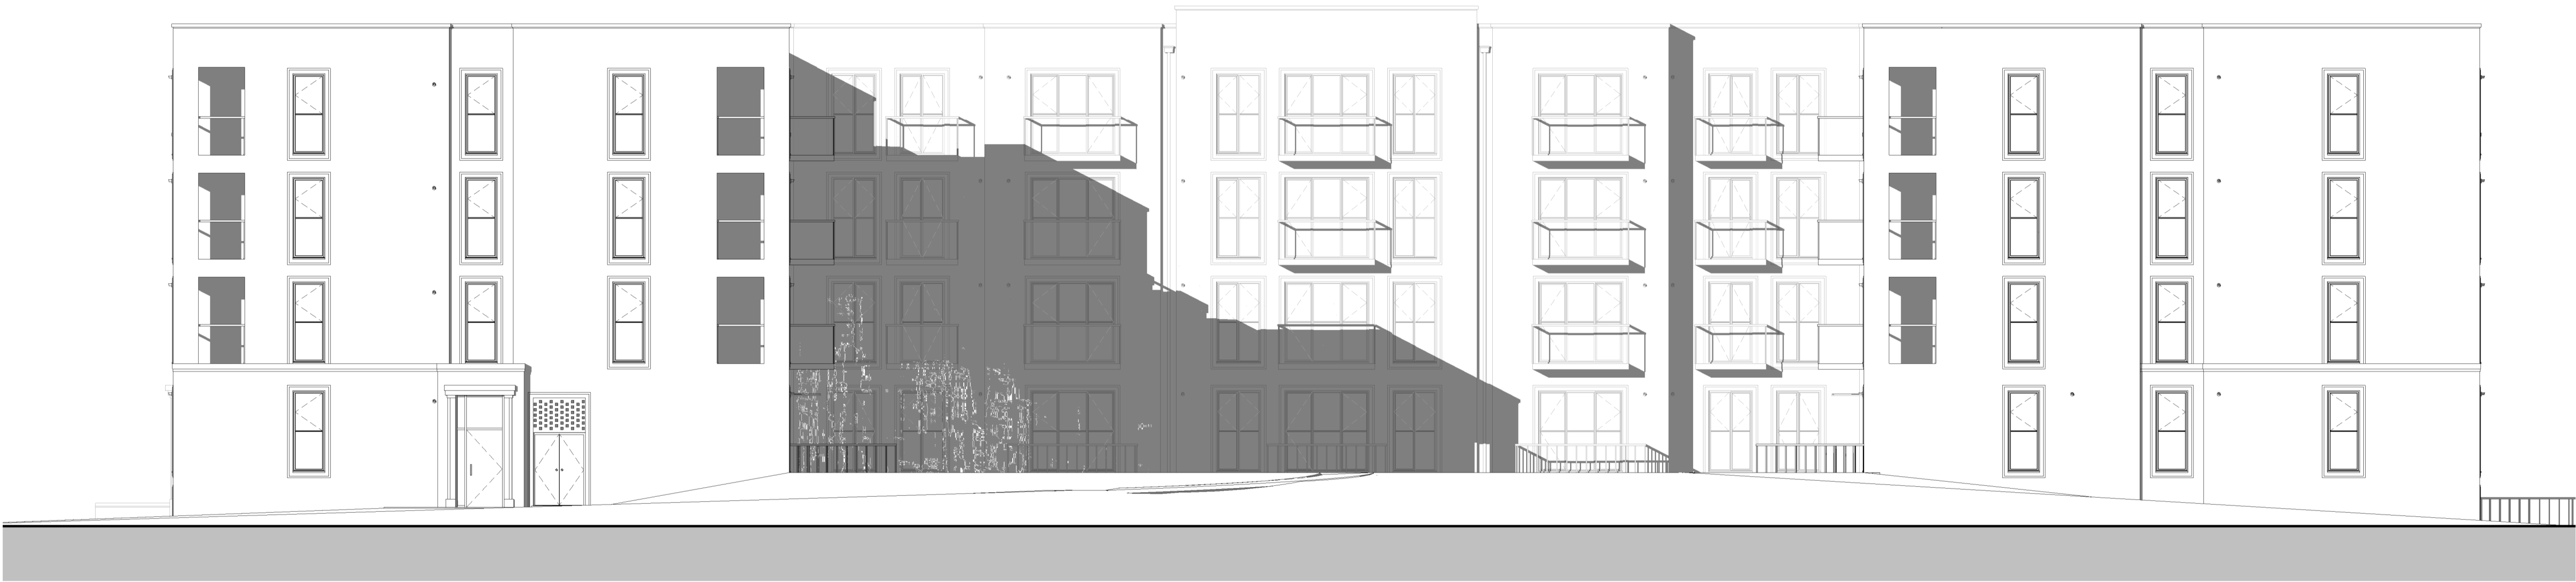P1.2	Issued for comments	25.10.19
P1.1	Issued for comments	04.10.19
Revision	Amendment	Date
JP	JD	JD
Drawn by	Reviewed by	Approved by
60193	SEPT 19	1 : 100 @ A1
MCB Number	Date Created	Scale @ A1
<div>McBains</div> <div>McBains Ltd</div> <div>5th Fl, 26 Finsbury Square London EC2A 1DS</div> <div>+44 (0)20 7786 7900 mcbains.co.uk</div>		
Client Hightown Housing Association		
Project 29 Broadwater Road Welwyn Garden City		
Drawing Title South Elevation		
ARCHITECTURE		
Drawing / Document Reference		Status
BRW01 - MCB - ZZ - ZZ - DR - A - 0503		SZ - P1.2
Project Idm	Originator	Zone
	Level	Type
	Discipline	Number
	Suitability	Revision

Notes
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West Elevation
1 : 100

DRAFT



West Elevation - Patio
1 : 100

P1.2
P1.1

Issued for comments
Issued for comments

25.10.19
04.10.19

Revision	Amendment	Date
JP	JD	JD
Drawn by	Reviewed by	Approved by
60193	SEPT 19	1 : 100 @ A1
MCB Number	Date Created	Scale @ A1



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Client
Hightown Housing Association

Project
29 Broadwater Road
Welwyn Garden City

Drawing Title
West Elevations

ARCHITECTURE


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BRW01	-	MCB	-	ZZ	-	ZZ - DR - A - 0500	S2 - P1.2
Project Idn	Originator	Zone	Level	Type	Discipline	Number	Suitability Revision

Appendix A.2 – Graphical Model Outputs

Proposed Site Scenario
North East Facing View




Proposed Site Scenario
North West Facing View

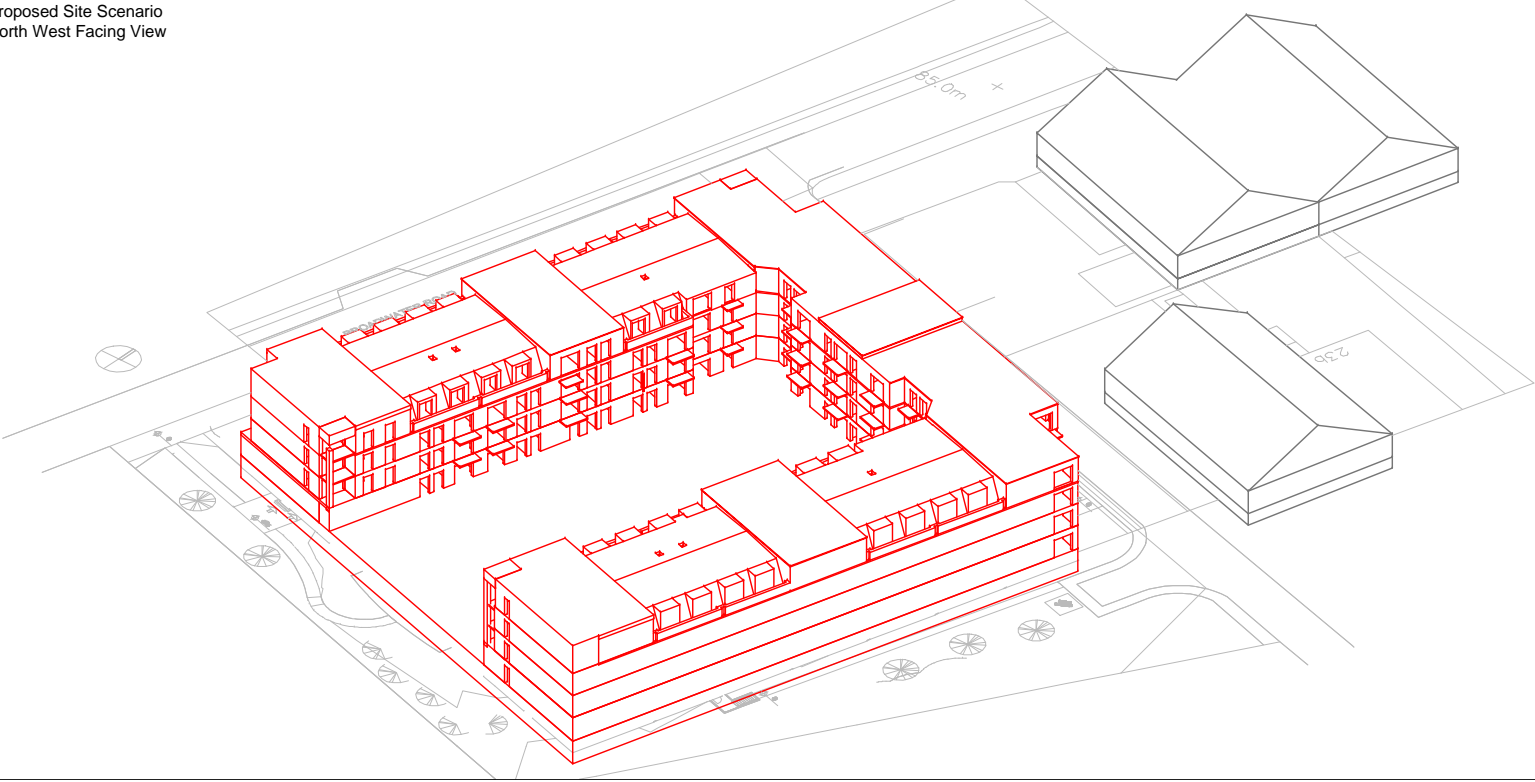

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Legend



Proposed Buildings Surrounding Buildings

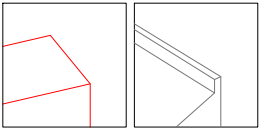Location Plan



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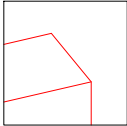
CLIENT
Hightown Housing Association

PROJECT
Broadwater Road, Hertfordshire


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DWG REF 3D Model - Existing & Proposed Site Scenarios.	DWG No. 2405_01
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Legend




Proposed Buildings



Surrounding Buildings

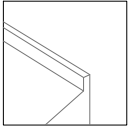Location Plan

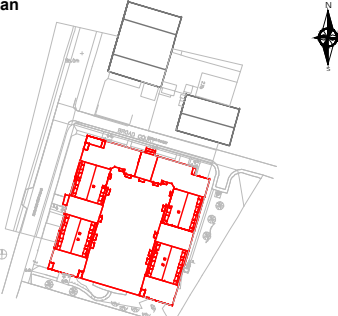

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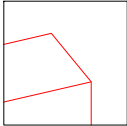
PROJECT	
Broadwater Road, Hertfordshire	

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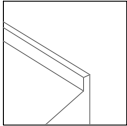
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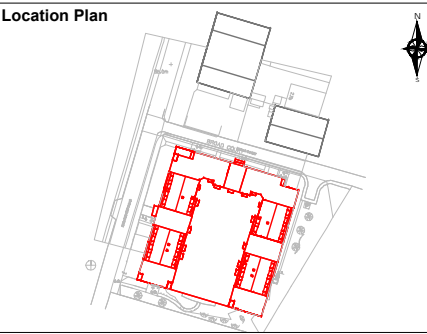
Legend



Proposed Buildings



Surrounding Buildings



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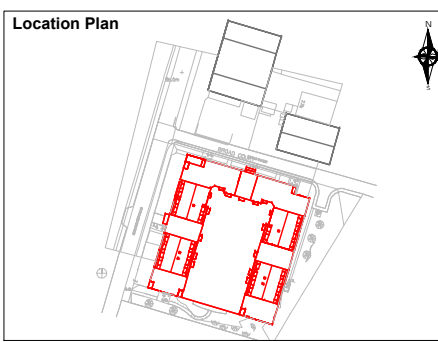
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Legend

Proposed Buildings

Surrounding Buildings



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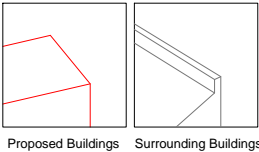
PROJECT

Broadwater Road, Hertfordshire


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Not to scale	2405	AP	YS

DWG REF. Window Receptors.	DWG No. 2405_04
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Legend



Location Plan

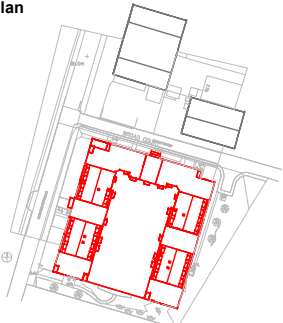

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PROJECT

Broadwater Road, Hertfordshire

SCALE

Not to scale

PROJ REF

2405

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DWG REF

Window Receptors.


DWG No.

2405_05

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Legend



Location Plan

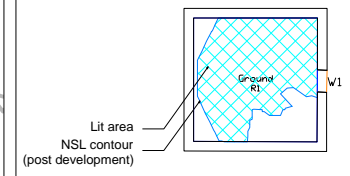


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DWG REF. NSL contours.	DWG No. 2405_06
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Legend

Lit area
NSL contour
(post development)

Location Plan

Location Plan

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CLIENT
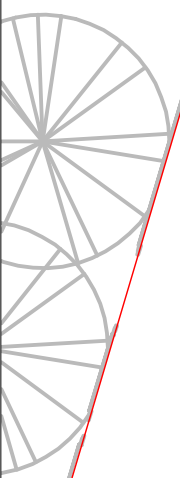
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PROJECT

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SCALE

Not to scale

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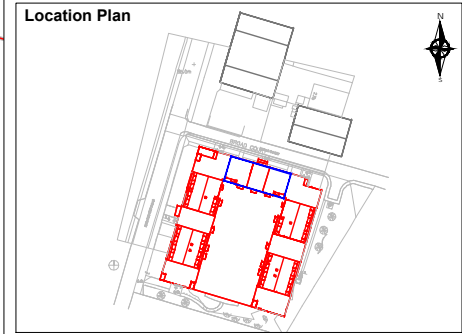
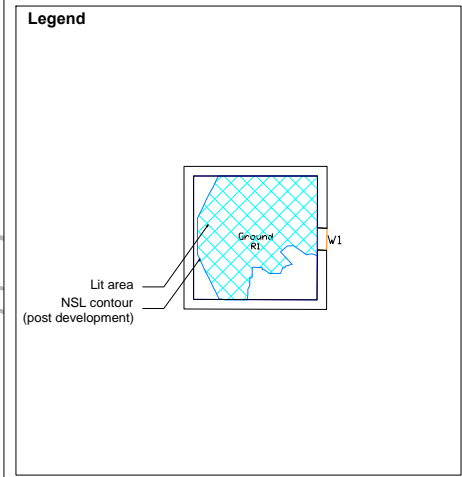
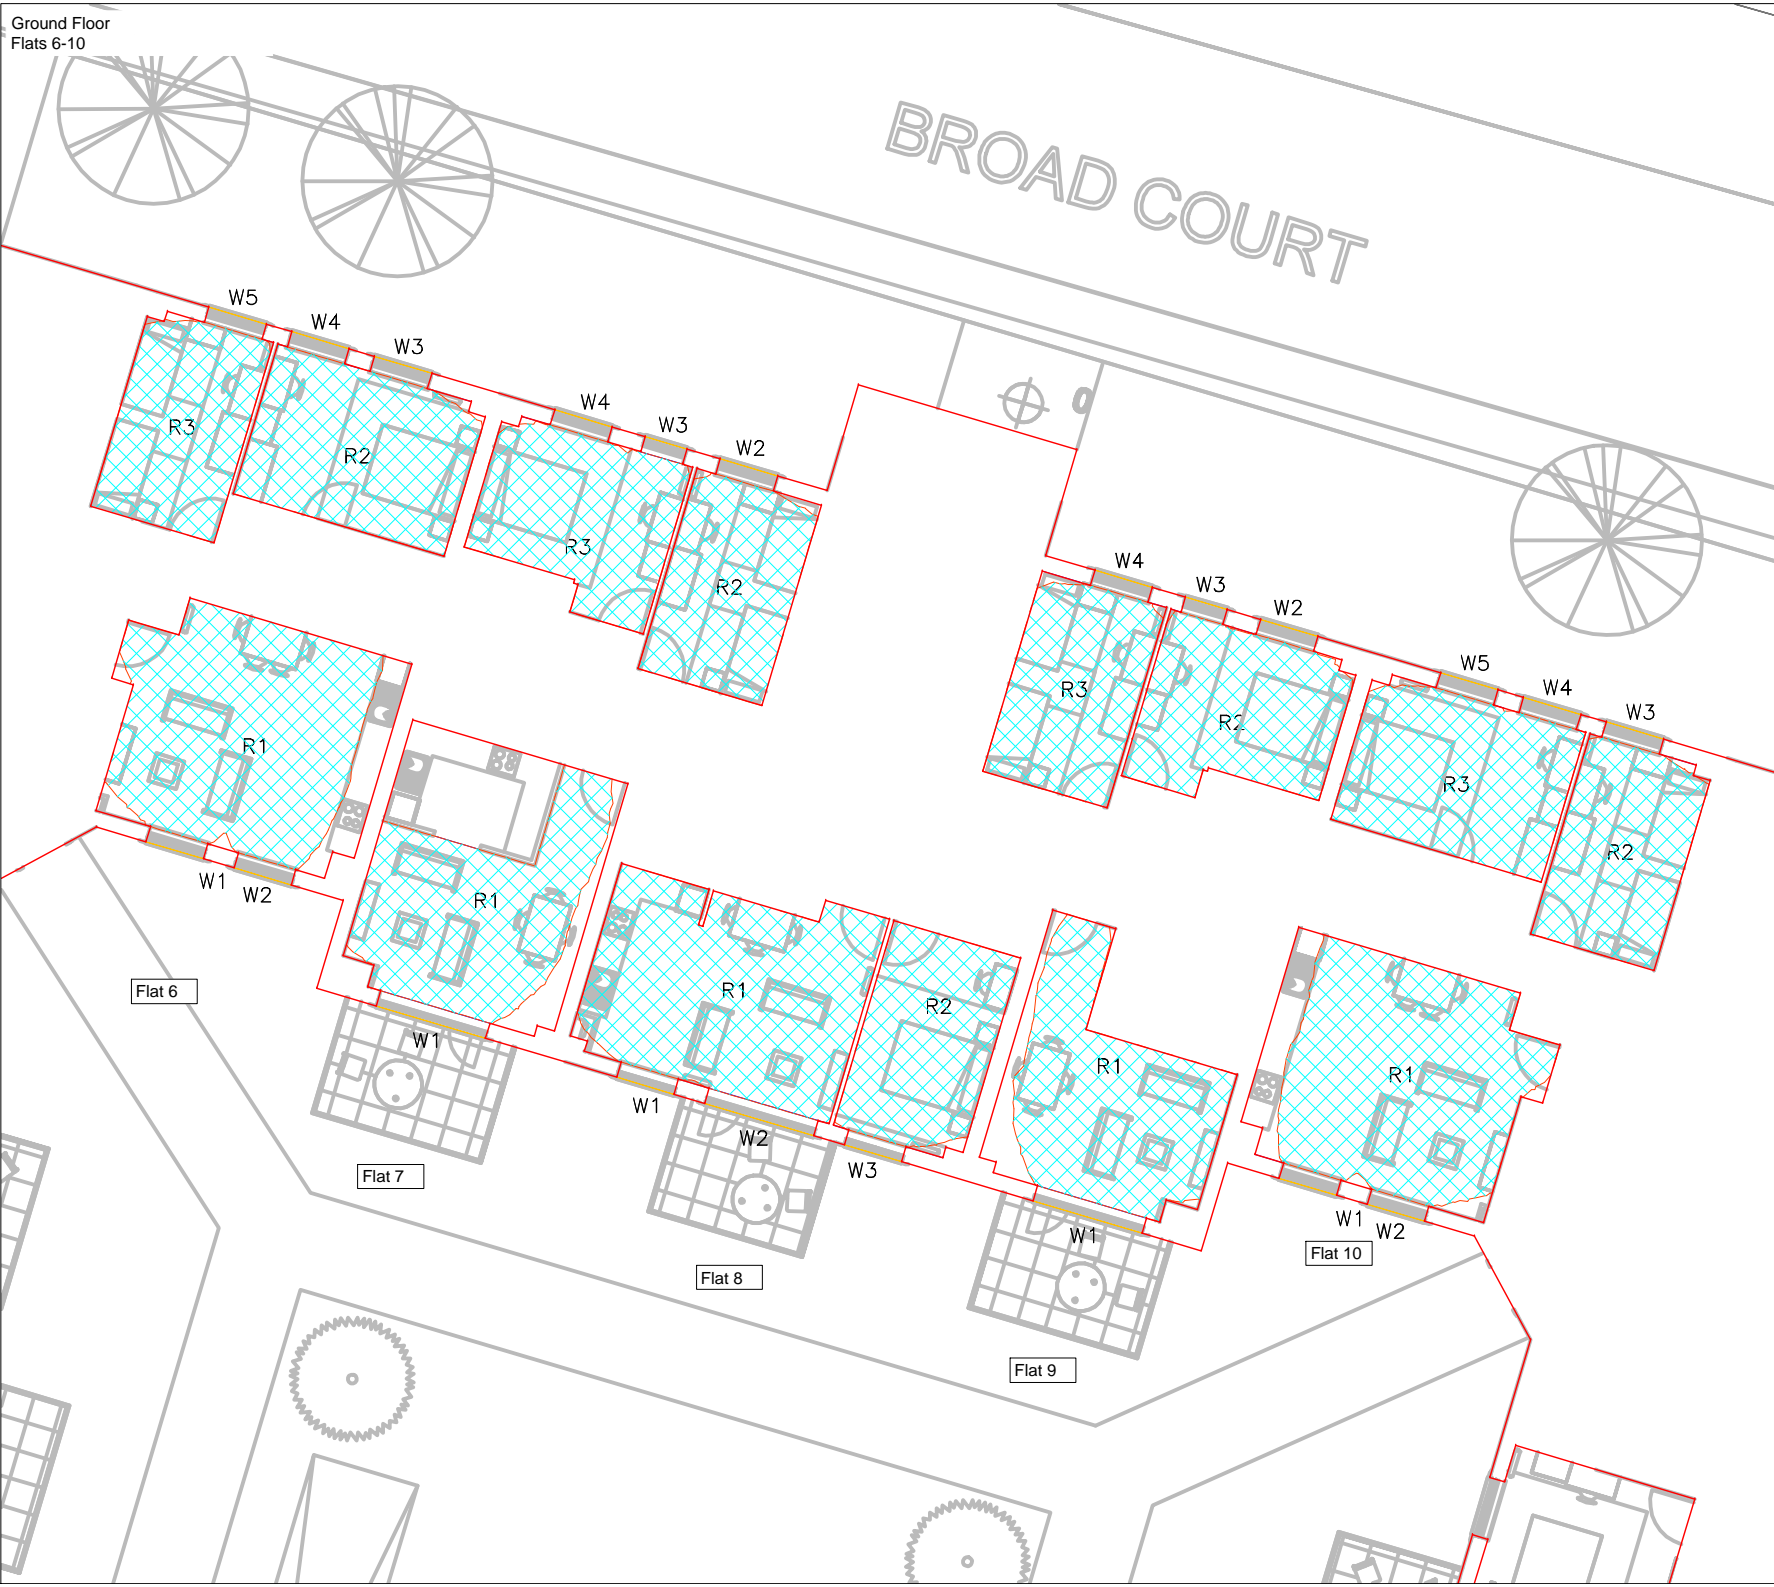
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DWG REF.

NSL contours.

DWG No.

2405_07





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DWG REF. NSL contours.	DWG No. 2405_08
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DWG REF.
3D Model - Existing & Proposed Site Scenarios.
NSL contours.
2hr SoG amenity contours.

DWG No.
2405_09

Ground Floor
Flats 14-16



Legend

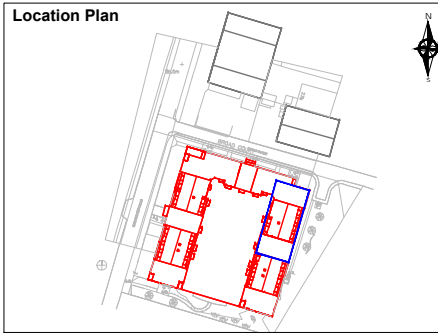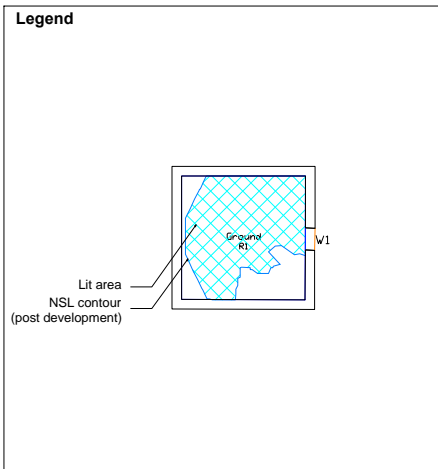Location Plan

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CLIENT



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Not to scale	2405	AP	YS

DWG REF. NSL contours.	DWG No. 2405_10
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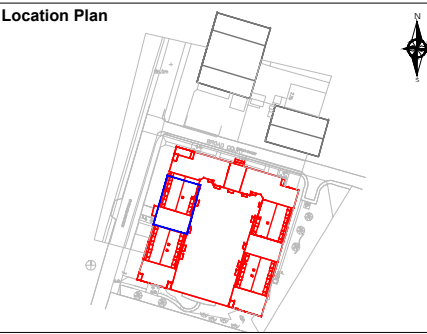
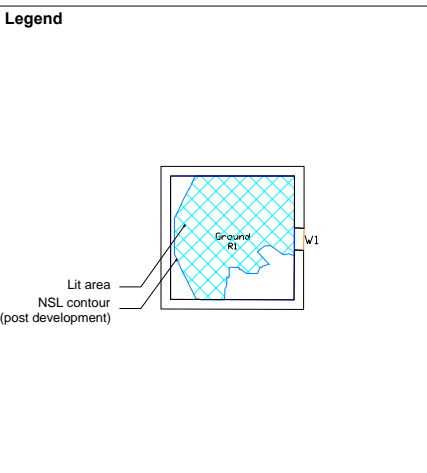
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Broadwater Road, Hertfordshire

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DWG REF.	DWG No.
NSL contours.	2405_11



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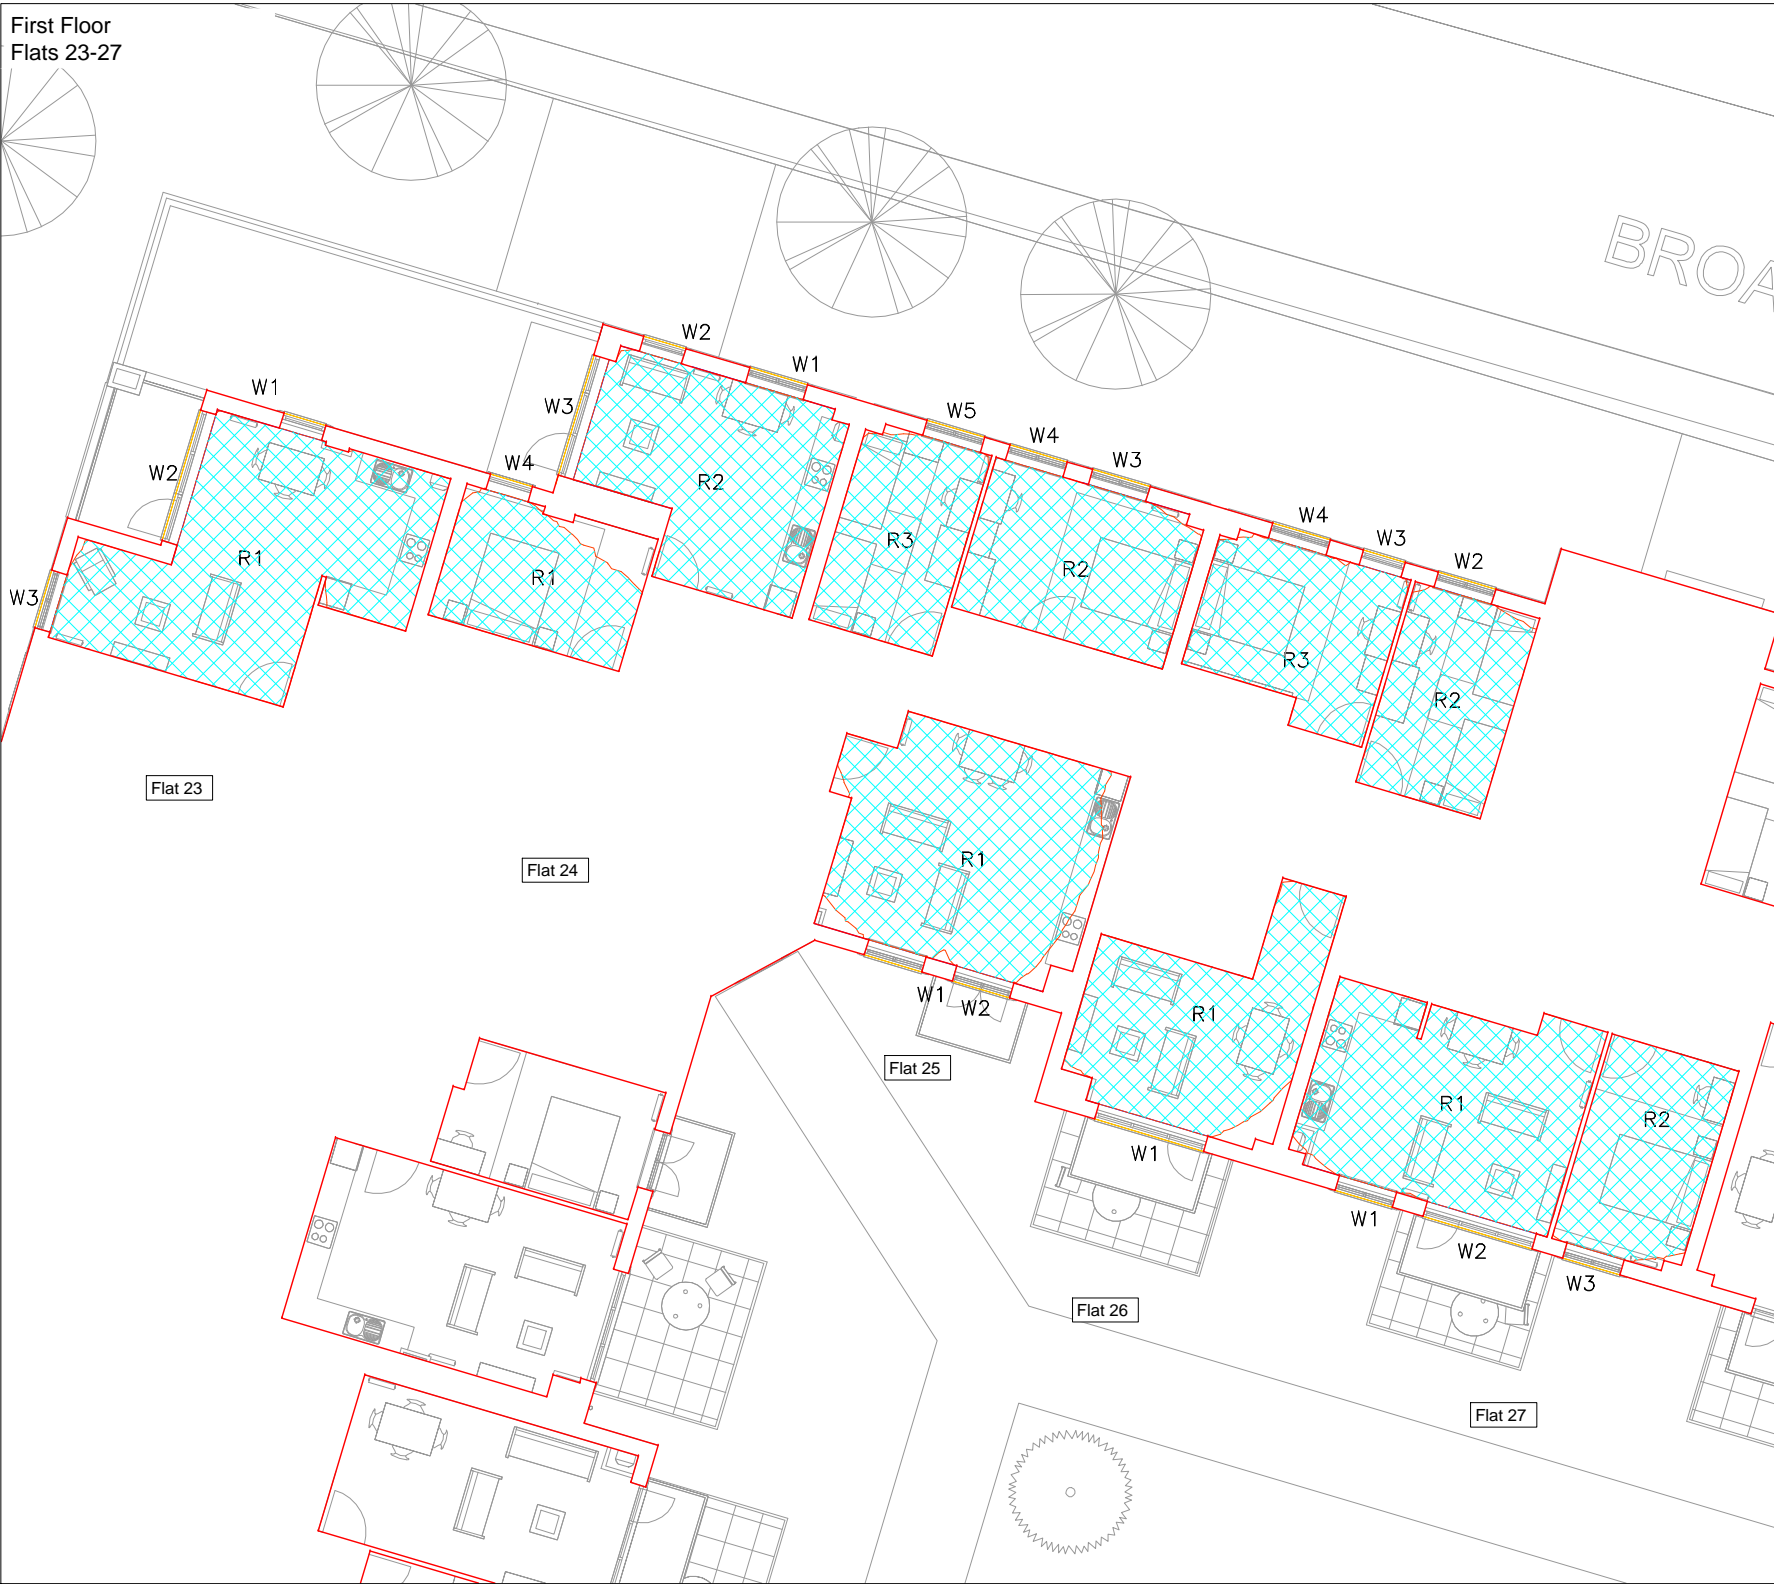
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PROJECT

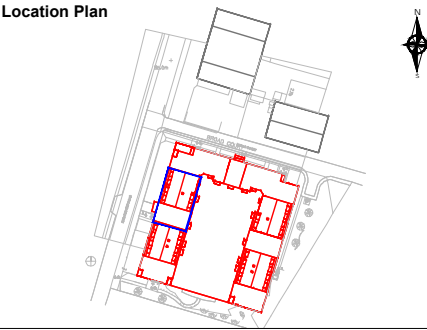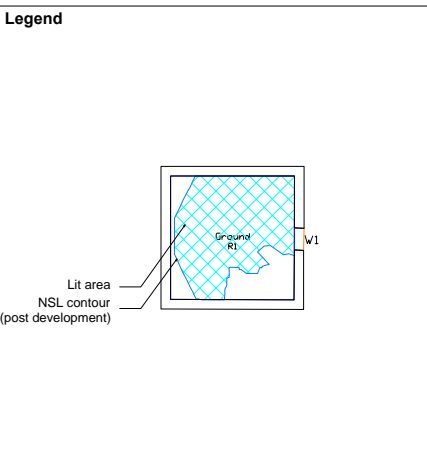
Broadwater Road, Hertfordshire

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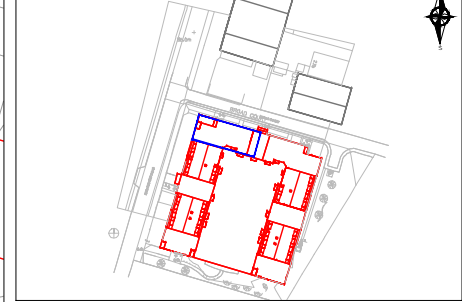
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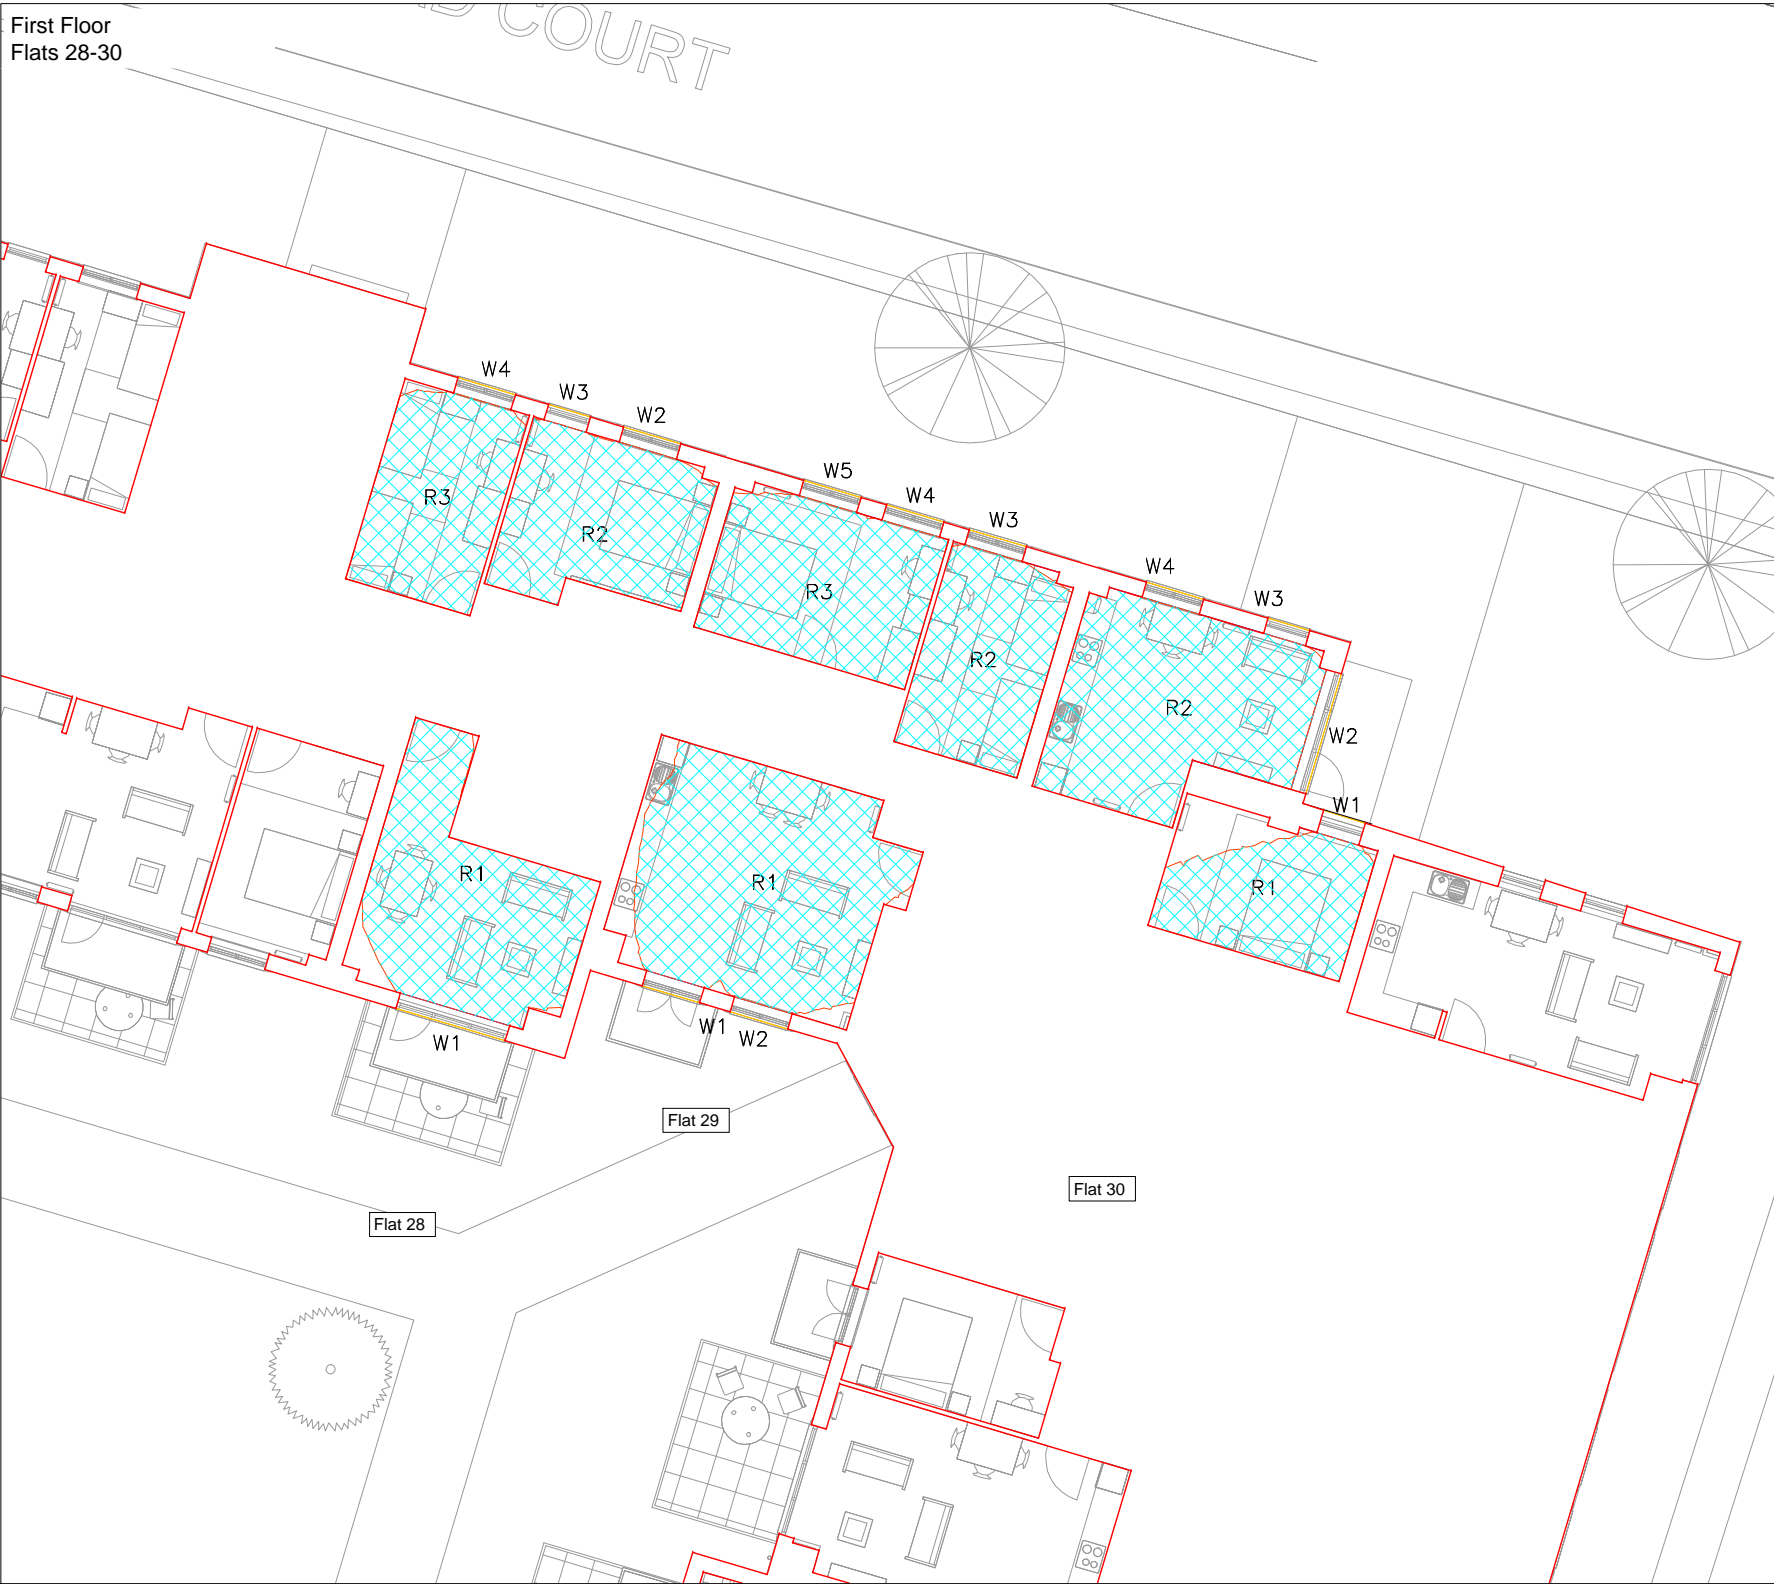
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Location Plan



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PROJECT		
Broadwater Road, Hertfordshire		
SCALE	PROJ REF	ANALYST
Not to scale	2405	AP
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DWG REF.		DWG No.
NSL contours.		2405_13

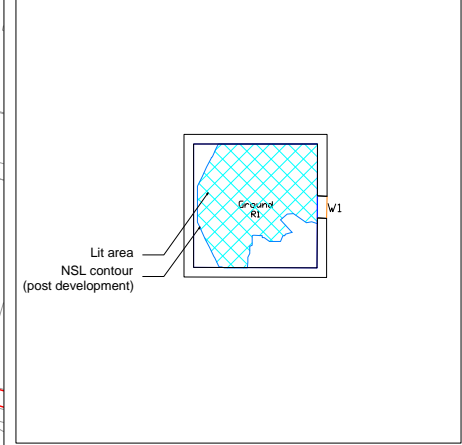

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Legend

Lit area
NSL contour
(post development)

Location Plan

North arrow

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PROJECT

Broadwater Road, Hertfordshire

SCALE

Not to scale

PROJ REF

2405

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DWG REF.

NSL contours.


DWG No.

2405_14



First Floor
Flats 31-33

Legend

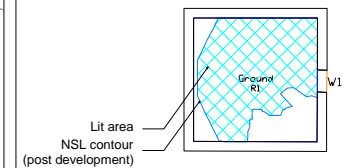

Location Plan



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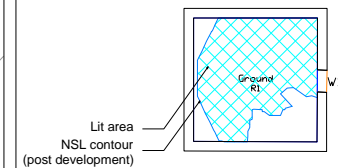
PROJECT
Broadwater Road, Hertfordshire

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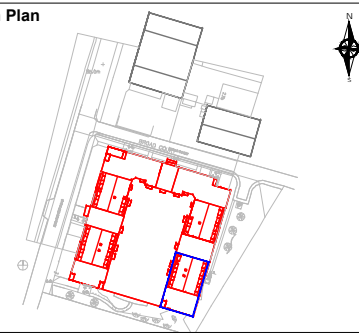
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Legend



Location Plan



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CLIENT
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PROJECT
Broadwater Road, Hertfordshire

SCALE	PROJ REF	ANALYST	DRAWN BY
Not to scale	2405	AP	YS

DWG REF. NSL contours.	DWG No. 2405_16
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Legend

Lit area

NSL contour


(post development)

Location Plan


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Rev	Description	Date
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Hightown Housing Association		
PROJECT		
Broadwater Road, Hertfordshire		
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Not to scale	2405	AP
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NSL contours.		2405_17



Legend

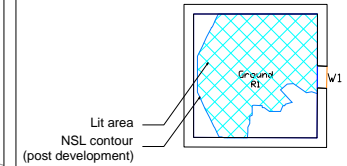

Location Plan

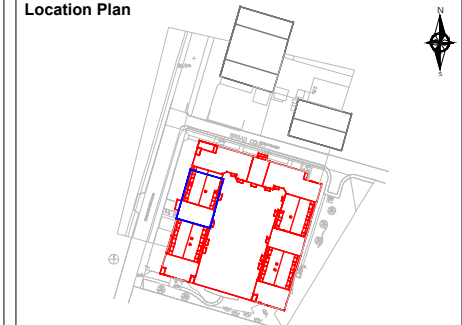

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Rev	Description	Date


CLIENT
Hightown Housing Association

PROJECT
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SCALE Not to scale	PROJ REF 2405	ANALYST AP	DRAWN BY YS
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Legend



Location Plan

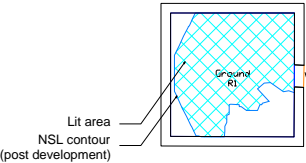

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Rev	Description	Date


CLIENT
Hightown Housing Association

PROJECT
Broadwater Road, Hertfordshire


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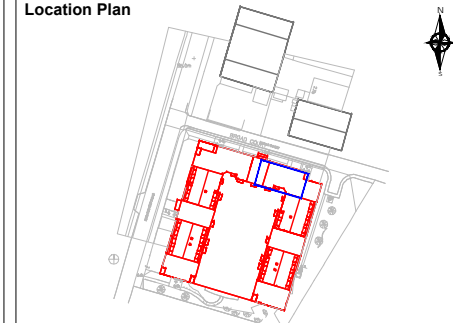
BROAD COURT



Legend

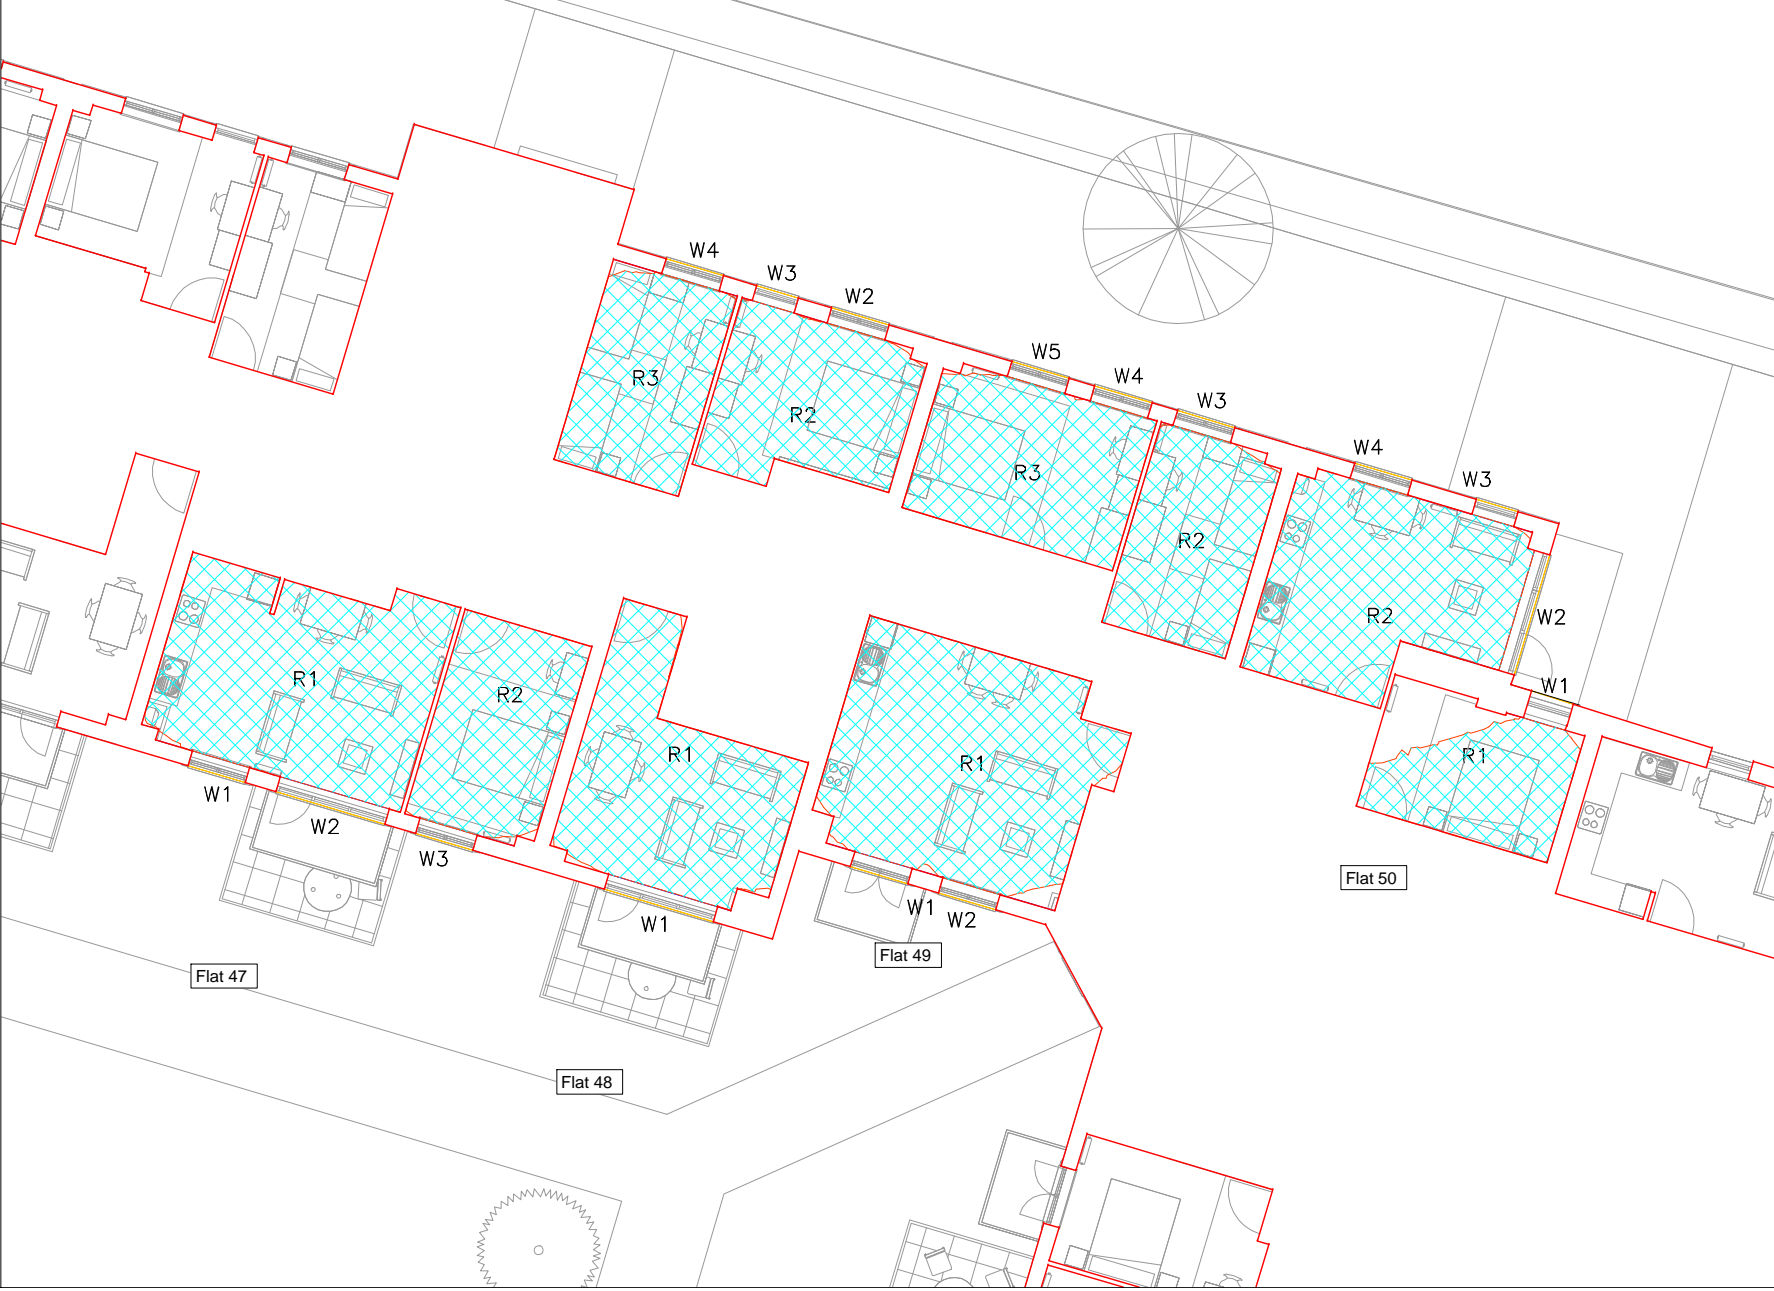

Location Plan

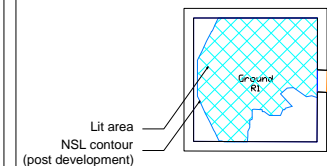

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CLIENT
Hightown Housing Association

PROJECT
Broadwater Road, Hertfordshire

SCALE Not to scale	PROJ REF 2405	ANALYST AP	DRAWN BY YS
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DWG REF. NSL contours.	DWG No. 2405_20
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Second Floor
Flats 50a-53

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Legend

Lit area
NSL contour
(post development)

Location Plan

North arrow pointing upwards.

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CLIENT		
Hightown Housing Association		
PROJECT		
Broadwater Road, Hertfordshire		
SCALE	PROJ REF	ANALYST
Not to scale	2405	AP
DWG REF.		DWG No.
NSL contours.		2405_21

Legend

Lit area

NSL contour

(post development)

Location Plan

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CLIENT

Hightown Housing Association

PROJECT

Broadwater Road, Hertfordshire

SCALE

Not to scale

PROJ REF

2405

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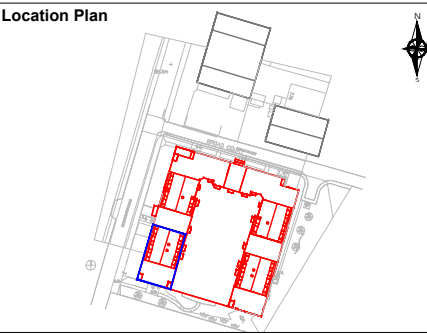
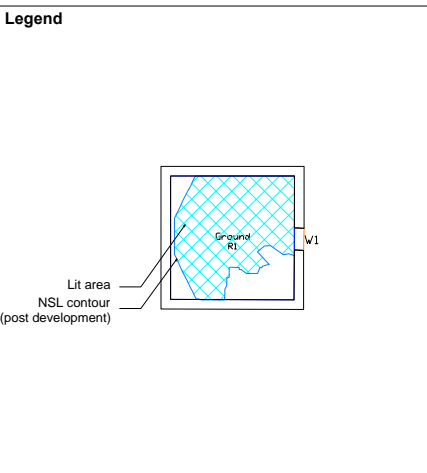
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DWG REF

NSL contours.

DWG No.

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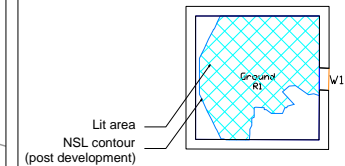


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Rev	Description	Date
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PROJECT		
Broadwater Road, Hertfordshire		
SCALE	PROJ REF	ANALYST
Not to scale	2405	AP
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DWG REF.		DWG No.
NSL contours.		2405_23

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Legend



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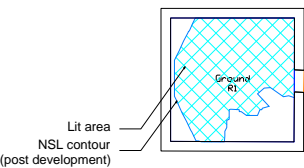
CLIENT
Hightown Housing Association

PROJECT
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SCALE	PROJ REF	ANALYST	DRAWN BY
Not to scale	2405	AP	YS

DWG REF. NSL contours.	DWG No. 2405_24
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Legend



Location Plan



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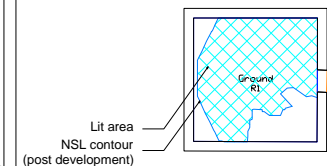
PROJECT
Broadwater Road, Hertfordshire

SCALE	PROJ REF	ANALYST	DRAWN BY
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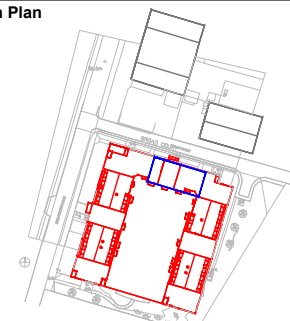
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BROAD COURT

Legend



Location Plan



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Hightown Housing Association		
PROJECT		
Broadwater Road, Hertfordshire		
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Not to scale	2405	AP
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NSL contours.		2405_26



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Legend

Lit area
NSL contour
(post development)

Location Plan

North Arrow

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PROJECT

Broadwater Road, Hertfordshire

SCALE

Not to scale

PROJ REF

2405

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DWG REF.

NSL contours.

DWG No.

2405_27

Legend

Lit area

NSL contour

(post development)

Location Plan

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CLIENT




Hightown Housing Association

PROJECT

Broadwater Road, Hertfordshire

SCALE	PROJ REF	ANALYST	DRAWN BY
Not to scale	2405	AP	YS

DWG REF.	DWG No.
NSL contours.	2405_28

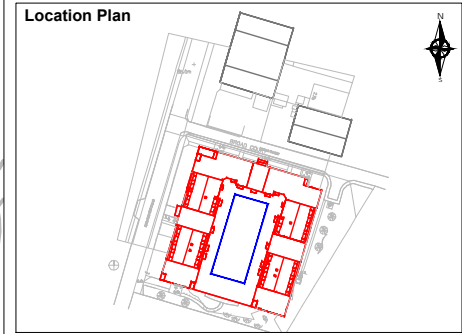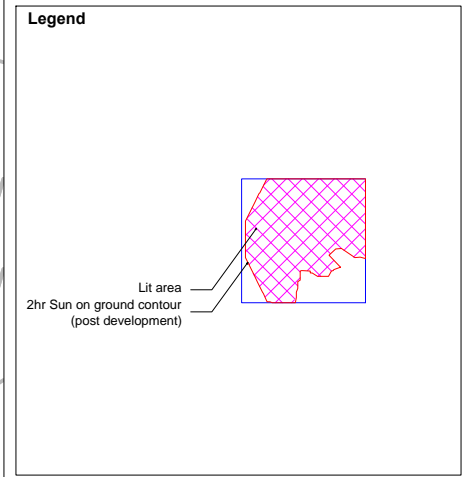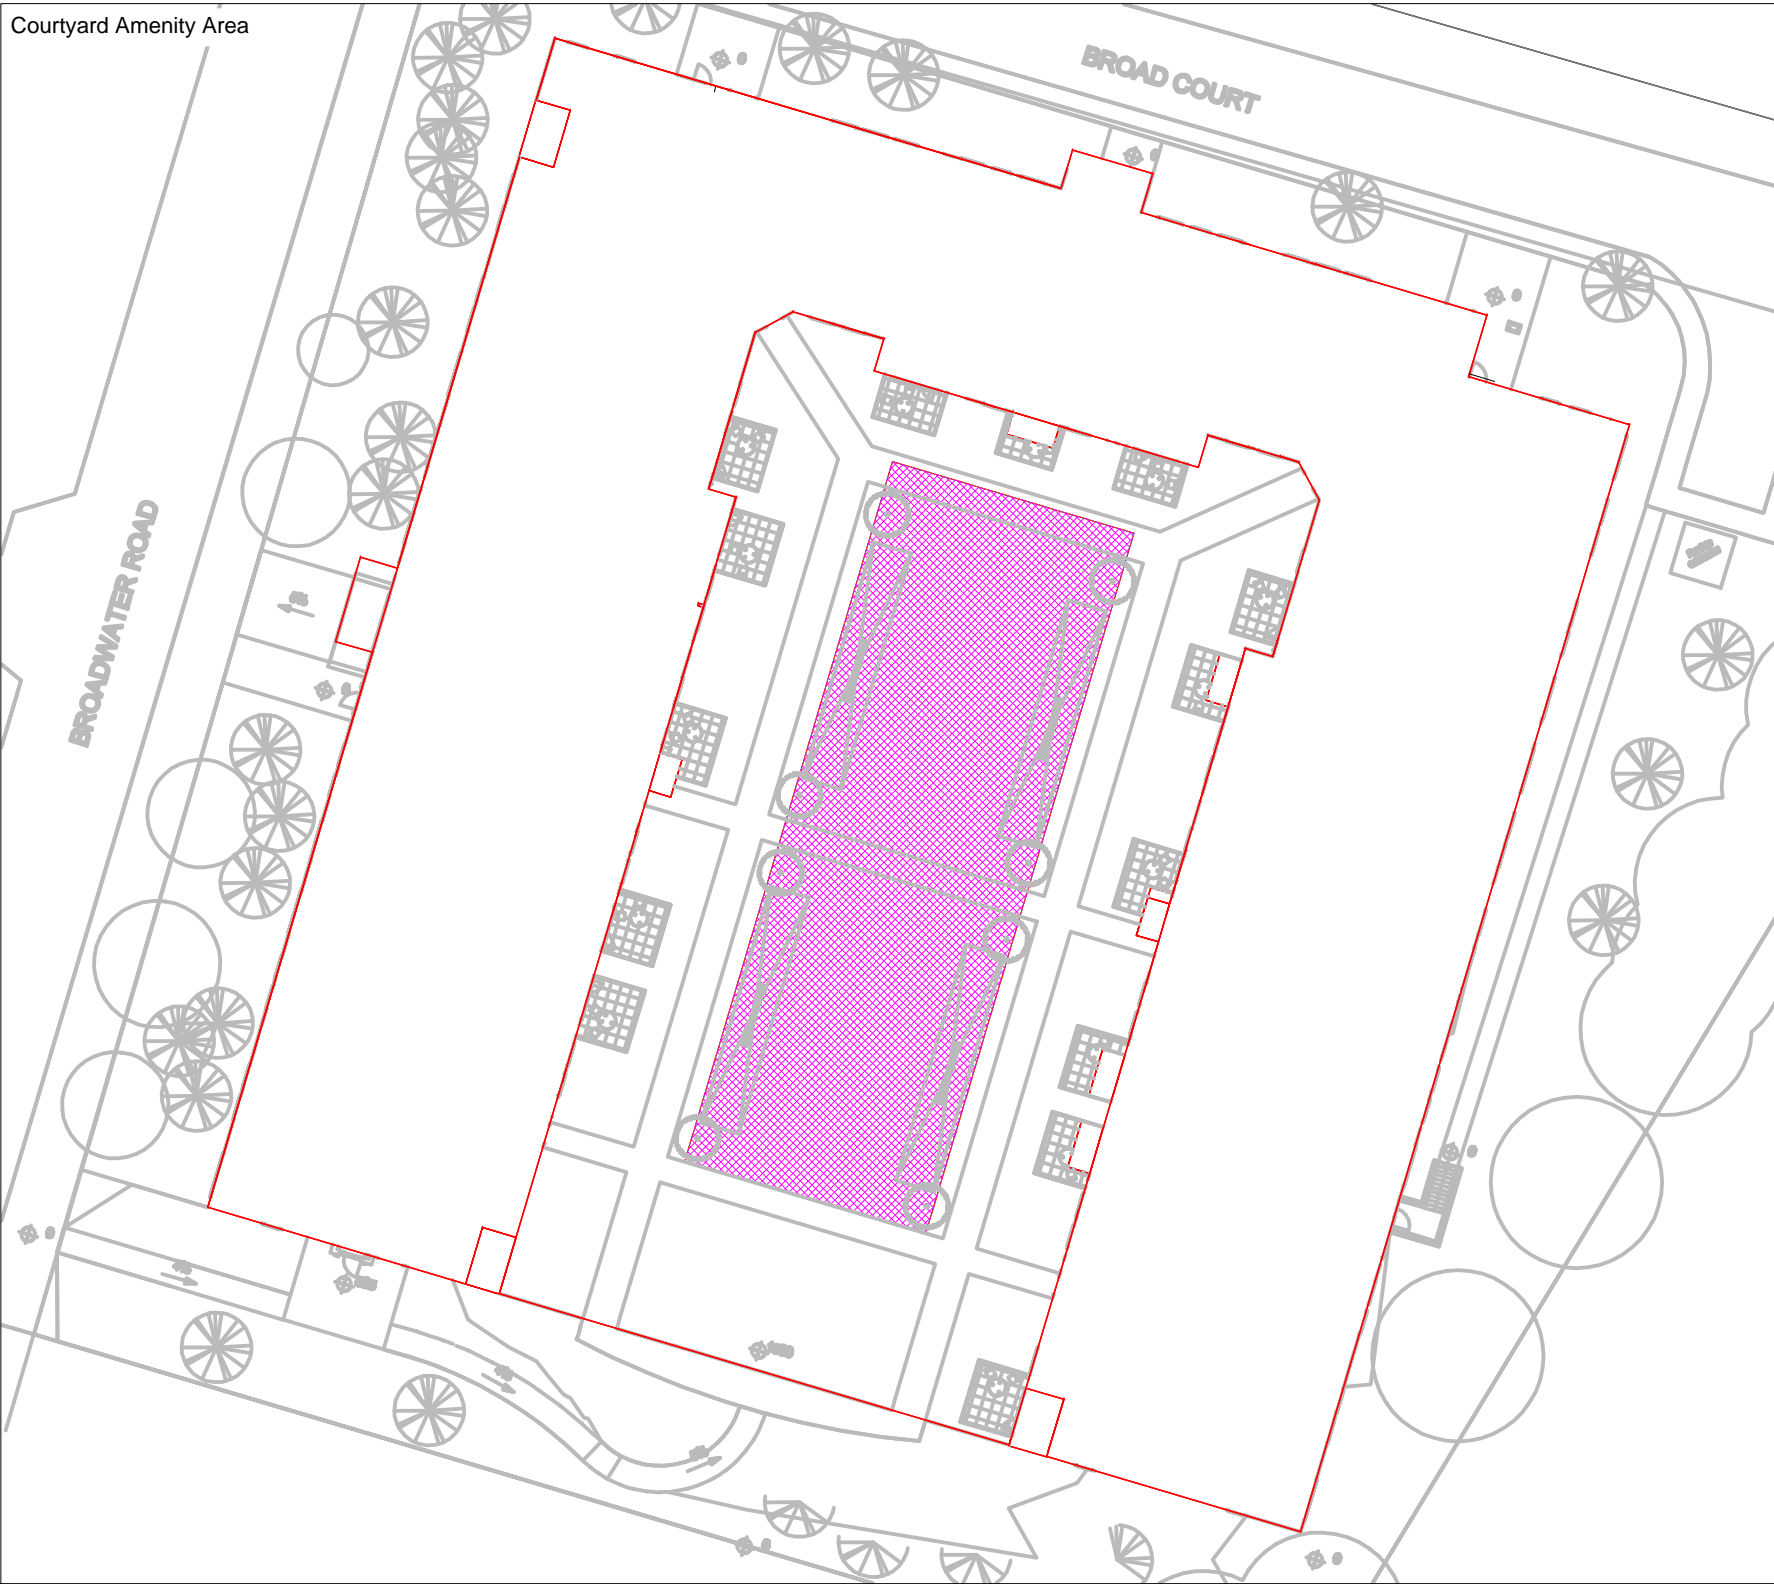

00	First issue	30/08/2019
Rev	Description	Date

CLIENT
Hightown Housing Association

PROJECT
Broadwater Road, Hertfordshire

SCALE	PROJ REF	ANALYST	DRAWN BY
Not to scale	2405	AP	YS

DWG REF. 2hr SoG amenity contours.	DWG No. 2405_29
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Appendix A.3 – Tabulated Results for Daylight and Sunlight Calculations (Provision to New Development)

Project Name: Broadwater Road, Hertfordshire
 Project No.: 2405
 Report Title: Average Daylight Analysis - Proposed Scheme Test
 Date: 27/08/2019



Floor Ref.	Room Ref.	Property Type	Room Use.	Window Ref.	Glass Transmittance	Maintenance Factor	Glazed Area	Clear Sky Angle Proposed	Room Surface Area	Average Surface Reflectance	Below Working Plane Factor	ADF Proposed	Req'd Value	Meets BRE Criteria
Flat 1														
Ground	R1	Residential	Bedroom	W1-L	0.78	0.92	0.85	71.25	73.02	0.65	0.15	0.16		
				W1-U	0.78	0.92	1.45	71.48	73.02	0.65	1.00	1.77		
												1.93	1.00	YES
Ground	R2	Residential	Bedroom	W2-L	0.78	0.92	0.85	69.39	62.94	0.65	0.15	0.18		
				W2-U	0.78	0.92	1.45	69.38	62.94	0.65	1.00	2.00		
												2.17	1.00	YES
Ground	R3	Residential	LD	W3-L	0.78	0.92	1.61	62.70	88.61	0.65	0.15	0.21		
				W3-U	0.78	0.92	2.75	49.78	88.61	0.65	1.00	1.94		
												2.15	1.50	YES
Flat 2														
Ground	R1	Residential	LD	W1-L	0.78	0.92	1.50	61.63	89.15	0.65	0.15	0.20		
				W1-U	0.78	0.92	2.56	48.85	89.15	0.65	1.00	1.76		
												1.95	1.50	YES
Ground	R2	Residential	Bedroom	W2-L	0.78	0.92	0.85	66.94	60.63	0.65	0.15	0.18		
				W2-U	0.78	0.92	1.45	67.22	60.63	0.65	1.00	2.01		
												2.18	1.00	YES
Ground	R3	Residential	Bedroom	W3-L	0.78	0.92	0.85	67.34	63.13	0.65	0.15	0.17		
				W3-U	0.78	0.92	1.45	68.07	63.13	0.65	1.00	1.95		
												2.12	1.00	YES
Flat 3														
Ground	R1	Residential	LKD	W1-L	0.78	0.92	0.85	60.11	108.79	0.65	0.15	0.09		
				W1-U	0.78	0.92	1.45	48.47	108.79	0.65	1.00	0.81		
				W2-L	0.78	0.92	0.85	64.25	108.79	0.65	0.15	0.09		
				W2-U	0.78	0.92	1.45	64.09	108.79	0.65	1.00	1.07		
												2.06	2.00	YES

Project Name: Broadwater Road, Hertfordshire
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										Average Surface Reflectance	Below Working Plane Factor	ADF Proposed	Req'd Value	Meets BRE Criteria
Floor Ref.	Room Ref.	Property Type	Room Use.	Window Ref.	Glass Transmittance	Maintenance Factor	Glazed Area	Clear Sky Angle Proposed	Room Surface Area					
Ground	R2	Residential	Bedroom	W3-L	0.78	0.92	0.85	65.47	72.47	0.65	0.15	0.14		
				W3-U	0.78	0.92	1.45	66.26	72.47	0.65	1.00	1.66		
													1.80	1.00
Flat 4														
Ground	R1	Residential	Bedroom	W1-L	0.78	0.92	0.85	64.23	69.46	0.65	0.15	0.15		
				W1-U	0.78	0.92	1.45	65.10	69.46	0.65	1.00	1.70		
													1.85	1.00
Ground	R2	Residential	Bedroom	W2-L	0.78	0.92	0.85	62.05	56.67	0.65	0.15	0.17		
				W2-U	0.78	0.92	1.45	63.52	56.67	0.65	1.00	2.03		
													2.21	1.00
Ground	R3	Residential	LD	W3-L	0.78	0.92	1.61	54.66	87.92	0.65	0.15	0.19		
				W3-U	0.78	0.92	2.75	41.84	87.92	0.65	1.00	1.64		
													1.83	1.50
Flat 5														
Ground	R1	Residential	LKD	W1-L	0.78	0.92	1.61	50.66	92.22	0.65	0.15	0.17		
				W1-U	0.78	0.92	2.75	51.93	92.22	0.65	1.00	1.94		
													2.11	2.00
Ground	R2	Residential	Bedroom	W2-L	0.78	0.92	0.85	45.44	62.71	0.65	0.15	0.12		
				W2-U	0.78	0.92	1.45	37.01	62.71	0.65	1.00	1.07		
													1.18	1.00
Flat 6														
Ground	R1	Residential	LKD	W1-L	0.78	0.92	0.85	49.07	107.16	0.65	0.15	0.07		
				W1-U	0.78	0.92	1.45	48.35	107.16	0.65	1.00	0.82		
				W2-L	0.78	0.92	0.85	44.46	107.16	0.65	0.15	0.07		
				W2-U	0.78	0.92	1.45	36.26	107.16	0.65	1.00	0.61		
													1.57	2.00
Ground	R2	Residential	Bedroom	W3-L	0.78	0.92	0.85	79.91	69.99	0.65	0.15	0.18		
				W3-U	0.78	0.92	1.45	79.71	69.99	0.65	1.00	2.06		

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Floor Ref.	Room Ref.	Property Type	Room Use.	Window Ref.	Glass Transmittance	Maintenance Factor	Glazed Area	Clear Sky Angle Proposed	Room Surface Area	Average Surface Reflectance	Below Working Plane Factor	ADF Proposed	Req'd Value	Meets BRE Criteria
				W4-L	0.78	0.92	0.85	80.15	69.99	0.65	0.15	0.18	1.00	YES
				W4-U	0.78	0.92	1.45	79.89	69.99	0.65	1.00	2.07		
												4.50		
Ground	R3	Residential	Bedroom	W5-L	0.78	0.92	0.85	80.31	59.35	0.65	0.15	0.22	1.00	YES
				W5-U	0.78	0.92	1.45	80.02	59.35	0.65	1.00	2.44		
												2.66	1.00	YES
Flat 7														
Ground	R1	Residential	LD	W1-L	0.78	0.92	1.61	55.83	89.96	0.65	0.15	0.19	1.50	YES
				W1-U	0.78	0.92	2.75	43.55	89.96	0.65	1.00	1.67		
												1.86	1.50	YES
Ground	R2	Residential	Bedroom	W2-L	0.78	0.92	0.85	68.15	59.83	0.65	0.15	0.18	1.00	YES
				W2-U	0.78	0.92	1.45	69.99	59.83	0.65	1.00	2.12		
												2.30	1.00	YES
Ground	R3	Residential	Bedroom	W3-L	0.78	0.92	0.62	74.99	65.91	0.65	0.15	0.13	1.00	YES
				W3-U	0.78	0.92	1.06	76.09	65.91	0.65	1.00	1.53		
				W4-L	0.78	0.92	0.85	78.55	65.91	0.65	0.15	0.19		
				W4-U	0.78	0.92	1.45	78.82	65.91	0.65	1.00	2.17		
												4.01	1.00	YES
Flat 8														
Ground	R1	Residential	LKD	W1-L	0.78	0.92	0.85	62.54	102.32	0.65	0.15	0.10	2.00	YES
				W1-U	0.78	0.92	1.45	62.11	102.32	0.65	1.00	1.10		
				W2-L	0.78	0.92	1.61	58.85	102.32	0.65	0.15	0.17		
				W2-U	0.78	0.92	2.75	46.27	102.32	0.65	1.00	1.56		
												2.93	2.00	YES
Ground	R2	Residential	Bedroom	W3-L	0.78	0.92	0.85	62.55	61.42	0.65	0.15	0.16	1.00	YES
				W3-U	0.78	0.92	1.45	62.12	61.42	0.65	1.00	1.83		
												1.99	1.00	YES

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Flat 9														
Ground	R1	Residential	LD	W1-L	0.78	0.92	1.61	55.83	89.98	0.65	0.15	0.19		
				W1-U	0.78	0.92	2.75	43.54	89.98	0.65	1.00	1.67		
												1.86	1.50	YES
Ground	R2	Residential	Bedroom	W2-L	0.78	0.92	0.85	75.32	65.91	0.65	0.15	0.18		
				W2-U	0.78	0.92	1.45	76.09	65.91	0.65	1.00	2.09		
				W3-L	0.78	0.92	0.62	72.16	65.91	0.65	0.15	0.13		
				W3-U	0.78	0.92	1.06	73.65	65.91	0.65	1.00	1.48		
												3.88	1.00	YES
Ground	R3	Residential	Bedroom	W4-L	0.78	0.92	0.85	65.10	59.83	0.65	0.15	0.17		
				W4-U	0.78	0.92	1.45	67.37	59.83	0.65	1.00	2.04		
												2.21	1.00	YES
Flat 10														
Ground	R1	Residential	LKD	W1-L	0.78	0.92	0.85	44.49	107.16	0.65	0.15	0.07		
				W1-U	0.78	0.92	1.45	36.27	107.16	0.65	1.00	0.61		
				W2-L	0.78	0.92	0.85	49.09	107.16	0.65	0.15	0.07		
				W2-U	0.78	0.92	1.45	48.37	107.16	0.65	1.00	0.82		
												1.57	2.00	NO
Ground	R2	Residential	Bedroom	W3-L	0.78	0.92	0.85	73.78	59.35	0.65	0.15	0.20		
				W3-U	0.78	0.92	1.45	74.61	59.35	0.65	1.00	2.28		
												2.48	1.00	YES
Ground	R3	Residential	Bedroom	W4-L	0.78	0.92	0.85	74.19	69.99	0.65	0.15	0.17		
				W4-U	0.78	0.92	1.45	74.93	69.99	0.65	1.00	1.94		
				W5-L	0.78	0.92	0.85	74.91	69.99	0.65	0.15	0.17		
				W5-U	0.78	0.92	1.45	75.52	69.99	0.65	1.00	1.95		
												4.23	1.00	YES
Flat 10a														
Ground	R1	Residential	LKD	W1-L	0.78	0.92	1.61	88.46	104.75	0.65	0.15	0.26		

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				W1-U	0.78	0.92	2.75	86.33	104.75	0.65	1.00	2.84		
				W2-L	0.78	0.92	0.62	72.32	104.75	0.65	0.15	0.08		
				W2-U	0.78	0.92	1.06	72.89	104.75	0.65	1.00	0.92		
				W3-L	0.78	0.92	0.62	68.73	104.75	0.65	0.15	0.08		
				W3-U	0.78	0.92	1.06	69.41	104.75	0.65	1.00	0.88		
												5.05	2.00	YES
Flat 11														
Ground	R1	Residential	Bedroom	W1-L	0.78	0.92	0.85	45.52	62.85	0.65	0.15	0.12		
				W1-U	0.78	0.92	1.45	37.21	62.85	0.65	1.00	1.07		
												1.19	1.00	YES
Ground	R2	Residential	LKD	W2-L	0.78	0.92	1.61	50.63	92.79	0.65	0.15	0.17		
				W2-U	0.78	0.92	2.75	51.90	92.79	0.65	1.00	1.93		
												2.09	2.00	YES
Flat 12														
Ground	R1	Residential	LD	W1-L	0.78	0.92	1.61	54.77	87.92	0.65	0.15	0.19		
				W1-U	0.78	0.92	2.75	42.14	87.92	0.65	1.00	1.65		
												1.84	1.50	YES
Ground	R2	Residential	Bedroom	W2-L	0.78	0.92	0.85	62.08	56.67	0.65	0.15	0.17		
				W2-U	0.78	0.92	1.45	63.55	56.67	0.65	1.00	2.03		
												2.21	1.00	YES
Ground	R3	Residential	Bedroom	W3-L	0.78	0.92	0.85	64.25	69.45	0.65	0.15	0.15		
				W3-U	0.78	0.92	1.45	65.12	69.45	0.65	1.00	1.70		
												1.85	1.00	YES
Flat 13														
Ground	R1	Residential	Bedroom	W1-L	0.78	0.92	0.85	65.51	71.08	0.65	0.15	0.15		
				W1-U	0.78	0.92	1.45	66.29	71.08	0.65	1.00	1.69		
												1.84	1.00	YES
Ground	R2	Residential	LKD	W2-L	0.78	0.92	0.85	64.30	108.79	0.65	0.15	0.09		

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				W2-U	0.78	0.92	1.45	64.15	108.79	0.65	1.00	1.07		
				W3-L	0.78	0.92	0.85	60.22	108.79	0.65	0.15	0.09		
				W3-U	0.78	0.92	1.45	48.75	108.79	0.65	1.00	0.81		
												2.06	2.00	YES
Flat 14														
Ground	R1	Residential	Bedroom	W1-L	0.78	0.92	0.84	67.38	63.13	0.65	0.15	0.17		
				W1-U	0.78	0.92	1.44	68.10	63.13	0.65	1.00	1.95		
												2.12	1.00	YES
Ground	R2	Residential	Bedroom	W2-L	0.78	0.92	0.85	66.99	60.63	0.65	0.15	0.18		
				W2-U	0.78	0.92	1.45	67.28	60.63	0.65	1.00	2.01		
												2.19	1.00	YES
Ground	R3	Residential	LD	W3-L	0.78	0.92	1.61	61.86	89.15	0.65	0.15	0.21		
				W3-U	0.78	0.92	2.75	49.20	89.15	0.65	1.00	1.90		
												2.11	1.50	YES
Flat 15														
Ground	R1	Residential	LD	W1-L	0.78	0.92	1.61	62.80	88.61	0.65	0.15	0.21		
				W1-U	0.78	0.92	2.75	50.06	88.61	0.65	1.00	1.95		
												2.16	1.50	YES
Ground	R2	Residential	Bedroom	W2-L	0.78	0.92	0.85	69.43	62.94	0.65	0.15	0.18		
				W2-U	0.78	0.92	1.45	69.43	62.94	0.65	1.00	2.00		
												2.17	1.00	YES
Ground	R3	Residential	Bedroom	W3-L	0.78	0.92	0.85	71.28	74.82	0.65	0.15	0.15		
				W3-U	0.78	0.92	1.45	71.51	74.82	0.65	1.00	1.73		
												1.88	1.00	YES
Flat 16														
Ground	R1	Residential	LKD	W1-L	0.78	0.92	0.85	73.96	103.23	0.65	0.15	0.11		
				W1-U	0.78	0.92	1.45	73.92	103.23	0.65	1.00	1.30		
				W2-L	0.78	0.92	1.61	76.55	103.23	0.65	0.15	0.22		

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				W2-U	0.78	0.92	2.75	75.97	103.23	0.65	1.00	2.54		
				W3-L	0.78	0.92	0.62	84.63	103.23	0.65	0.15	0.10		
				W3-U	0.78	0.92	1.06	83.44	103.23	0.65	1.00	1.07		
												5.34	2.00	YES
Flat 17														
First	R1	Residential	LKD	W1-L	0.78	0.92	0.62	84.63	135.91	0.65	0.15	0.07		
				W1-U	0.78	0.92	1.06	83.44	135.91	0.65	1.00	0.81		
				W2-L	0.78	0.92	1.94	50.20	135.91	0.65	0.15	0.13		
				W2-U	0.78	0.92	3.31	37.08	135.91	0.65	1.00	1.13		
				W3-L	0.78	0.92	0.85	77.27	135.91	0.65	0.15	0.09		
				W3-U	0.78	0.92	1.45	77.21	135.91	0.65	1.00	1.03		
				W4-L	0.78	0.92	0.85	76.54	135.91	0.65	0.15	0.09		
				W4-U	0.78	0.92	1.45	76.58	135.91	0.65	1.00	1.02		
												4.38	2.00	YES
Flat 18														
First	R1	Residential	Bedroom	W1-L	0.78	0.92	0.85	75.28	70.49	0.65	0.15	0.17		
				W1-U	0.78	0.92	1.45	75.54	70.49	0.65	1.00	1.94		
												2.11	1.00	YES
First	R2	Residential	Bedroom	W2-L	0.78	0.92	0.85	73.71	60.65	0.65	0.15	0.19		
				W2-U	0.78	0.92	1.45	73.94	60.65	0.65	1.00	2.21		
												2.40	1.00	YES
First	R3	Residential	LD	W3-L	0.78	0.92	1.61	65.90	85.77	0.65	0.15	0.23		
				W3-U	0.78	0.92	2.75	50.18	85.77	0.65	1.00	2.02		
												2.25	1.50	YES
Flat 19														
First	R1	Residential	LD	W1-L	0.78	0.92	1.61	65.20	86.32	0.65	0.15	0.23		
				W1-U	0.78	0.92	2.75	49.62	86.32	0.65	1.00	1.98		
												2.21	1.50	YES

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First	R2	Residential	Bedroom	W2-L	0.78	0.92	0.85	71.87	58.34	0.65	0.15	0.20	1.00	YES
				W2-U	0.78	0.92	1.45	72.38	58.34	0.65	1.00	2.25		
												2.44		
First	R3	Residential	Bedroom	W3-L	0.78	0.92	0.85	72.19	60.79	0.65	0.15	0.19	1.00	YES
				W3-U	0.78	0.92	1.45	72.84	60.79	0.65	1.00	2.17		
Flat 20														
First	R1	Residential	LD	W1-L	0.78	0.92	1.61	64.40	81.11	0.65	0.15	0.24	1.50	YES
				W1-U	0.78	0.92	2.75	48.89	81.11	0.65	1.00	2.08		
First	R2	Residential	Bedroom	W2-L	0.78	0.92	0.85	69.32	48.60	0.65	0.15	0.23	1.00	YES
				W2-U	0.78	0.92	1.45	69.13	48.60	0.65	1.00	2.58		
First	R3	Residential	Bedroom	W3-L	0.78	0.92	0.86	70.77	62.83	0.65	0.15	0.18	1.00	YES
				W3-U	0.78	0.92	1.47	71.62	62.83	0.65	1.00	2.10		
Flat 21														
First	R1	Residential	Bedroom	W1-L	0.78	0.92	0.85	69.70	65.60	0.65	0.15	0.17	1.00	YES
				W1-U	0.78	0.92	1.45	70.83	65.60	0.65	1.00	1.96		
First	R2	Residential	Bedroom	W2-L	0.78	0.92	0.88	67.79	54.56	0.65	0.15	0.21	1.00	YES
				W2-U	0.78	0.92	1.50	69.22	54.56	0.65	1.00	2.38		
First	R3	Residential	LD	W3-L	0.78	0.92	1.61	59.32	85.87	0.65	0.15	0.21	1.50	YES
				W3-U	0.78	0.92	2.75	44.35	85.87	0.65	1.00	1.78		
Flat 22														
First	R1	Residential	LKD	W1-L	0.78	0.92	1.61	56.54	98.97	0.65	0.15	0.17		

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First	R2	Residential	Bedroom	W1-U	0.78	0.92	2.75	58.03	98.97	0.65	1.00	2.02	2.00	YES
				W2-L	0.78	0.92	0.85	50.19	57.23	0.65	0.15	0.14		
				W2-U	0.78	0.92	1.45	38.49	57.23	0.65	1.00	1.22		
Flat 23														
First	R1	Residential	LKD	W1-L	0.78	0.92	0.62	77.45	120.64	0.65	0.15	0.07	2.00	YES
				W1-U	0.78	0.92	0.95	76.77	120.64	0.65	1.00	0.76		
				W2-L	0.78	0.92	1.93	53.14	120.64	0.65	0.15	0.16		
				W2-U	0.78	0.92	2.97	41.28	120.64	0.65	1.00	1.27		
				W3-L	0.78	0.92	0.85	86.71	120.64	0.65	0.15	0.11		
				W3-U	0.78	0.92	1.45	85.15	120.64	0.65	1.00	1.28		
Flat 24														
First	R1	Residential	Bedroom	W4-L	0.78	0.92	0.62	50.76	58.28	0.65	0.15	0.10	1.00	YES
				W4-U	0.78	0.92	1.06	41.61	58.28	0.65	1.00	0.94		
												1.04		
First	R2	Residential	LKD	W1-L	0.78	0.92	0.85	83.45	85.99	0.65	0.15	0.15	2.00	YES
				W1-U	0.78	0.92	1.45	82.92	85.99	0.65	1.00	1.75		
				W2-L	0.78	0.92	0.62	81.66	85.99	0.65	0.15	0.11		
				W2-U	0.78	0.92	1.06	81.38	85.99	0.65	1.00	1.25		
				W3-L	0.78	0.92	1.93	51.05	85.99	0.65	0.15	0.21		
				W3-U	0.78	0.92	3.29	39.79	85.99	0.65	1.00	1.90		
Flat 25														
First	R1	Residential	LKD	W1-L	0.78	0.92	0.85	52.73	103.97	0.65	0.15	0.08		
				W1-U	0.78	0.92	1.45	52.36	103.97	0.65	1.00	0.91		
				W2-L	0.78	0.92	0.85	47.54	103.97	0.65	0.15	0.07		

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				W2-U	0.78	0.92	1.45	36.48	103.97	0.65	1.00	0.64		
												1.70	2.00	NO
First	R2	Residential	Bedroom	W3-L	0.78	0.92	0.85	83.03	67.66	0.65	0.15	0.20		
				W3-U	0.78	0.92	1.45	82.62	67.66	0.65	1.00	2.21		
				W4-L	0.78	0.92	0.85	83.13	67.66	0.65	0.15	0.20		
				W4-U	0.78	0.92	1.45	82.70	67.66	0.65	1.00	2.21		
												4.82	1.00	YES
First	R3	Residential	Bedroom	W5-L	0.78	0.92	0.85	83.24	57.24	0.65	0.15	0.23		
				W5-U	0.78	0.92	1.45	82.77	57.24	0.65	1.00	2.62		
												2.85	1.00	YES
Flat 26														
First	R1	Residential	LD	W1-L	0.78	0.92	1.61	59.86	86.87	0.65	0.15	0.21		
				W1-U	0.78	0.92	2.75	44.86	86.87	0.65	1.00	1.78		
												1.99	1.50	YES
First	R2	Residential	Bedroom	W2-L	0.78	0.92	0.85	75.37	57.68	0.65	0.15	0.21		
				W2-U	0.78	0.92	1.45	75.38	57.68	0.65	1.00	2.37		
												2.58	1.00	YES
First	R3	Residential	Bedroom	W3-L	0.78	0.92	0.62	80.19	63.92	0.65	0.15	0.15		
				W3-U	0.78	0.92	1.06	80.22	63.92	0.65	1.00	1.66		
				W4-L	0.78	0.92	0.85	82.70	63.92	0.65	0.15	0.21		
				W4-U	0.78	0.92	1.45	82.38	63.92	0.65	1.00	2.33		
												4.35	1.00	YES
Flat 27														
First	R1	Residential	LKD	W1-L	0.78	0.92	0.85	67.20	99.06	0.65	0.15	0.11		
				W1-U	0.78	0.92	1.45	66.71	99.06	0.65	1.00	1.22		
				W2-L	0.78	0.92	1.61	62.87	99.06	0.65	0.15	0.19		
				W2-U	0.78	0.92	2.75	47.80	99.06	0.65	1.00	1.66		
												3.18	2.00	YES
First	R2	Residential	Bedroom	W3-L	0.78	0.92	0.85	67.21	59.26	0.65	0.15	0.18		
				W3-U	0.78	0.92	1.45	66.71	59.26	0.65	1.00	2.04		

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												2.22	1.00	YES
Flat 28														
First	R1	Residential	LD	W1-L	0.78	0.92	1.61	59.95	86.87	0.65	0.15	0.21		
				W1-U	0.78	0.92	2.75	45.16	86.87	0.65	1.00	1.79		
												2.00	1.50	YES
First	R2	Residential	Bedroom	W2-L	0.78	0.92	0.85	80.72	63.92	0.65	0.15	0.20		
				W2-U	0.78	0.92	1.45	80.93	63.92	0.65	1.00	2.29		
				W3-L	0.78	0.92	0.62	78.61	63.92	0.65	0.15	0.14		
				W3-U	0.78	0.92	1.06	79.04	63.92	0.65	1.00	1.63		
												4.27	1.00	YES
First	R3	Residential	Bedroom	W4-L	0.78	0.92	0.85	73.96	57.71	0.65	0.15	0.20		
				W4-U	0.78	0.92	1.45	74.34	57.71	0.65	1.00	2.33		
												2.54	1.00	YES
Flat 29														
First	R1	Residential	LKD	W1-L	0.78	0.92	0.85	47.64	103.96	0.65	0.15	0.07		
				W1-U	0.78	0.92	1.45	36.69	103.96	0.65	1.00	0.64		
				W2-L	0.78	0.92	0.85	52.81	103.96	0.65	0.15	0.08		
				W2-U	0.78	0.92	1.45	52.47	103.96	0.65	1.00	0.91		
												1.71	2.00	NO
First	R2	Residential	Bedroom	W3-L	0.78	0.92	0.85	79.38	57.26	0.65	0.15	0.22		
				W3-U	0.78	0.92	1.45	80.01	57.26	0.65	1.00	2.53		
												2.75	1.00	YES
First	R3	Residential	Bedroom	W4-L	0.78	0.92	0.85	79.64	67.66	0.65	0.15	0.19		
				W4-U	0.78	0.92	1.45	80.21	67.66	0.65	1.00	2.15		
				W5-L	0.78	0.92	0.85	80.03	67.66	0.65	0.15	0.19		
				W5-U	0.78	0.92	1.45	80.47	67.66	0.65	1.00	2.15		
												4.68	1.00	YES

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Flat 30														
First	R1	Residential	Bedroom	W1-L	0.78	0.92	0.62	49.84	58.27	0.65	0.15	0.10		
				W1-U	0.78	0.92	1.06	41.38	58.27	0.65	1.00	0.94		
												1.04	1.00	YES
First	R2	Residential	LKD	W2-L	0.78	0.92	1.77	50.94	85.98	0.65	0.15	0.20		
				W2-U	0.78	0.92	3.02	39.82	85.98	0.65	1.00	1.75		
				W3-L	0.78	0.92	0.62	77.37	85.98	0.65	0.15	0.10		
				W3-U	0.78	0.92	1.06	78.31	85.98	0.65	1.00	1.20		
				W4-L	0.78	0.92	0.85	79.15	85.98	0.65	0.15	0.15		
				W4-U	0.78	0.92	1.45	79.86	85.98	0.65	1.00	1.68		
Flat 31														
First	R1	Residential	Bedroom	W1-L	0.78	0.92	0.85	50.28	57.22	0.65	0.15	0.14		
				W1-U	0.78	0.92	1.45	38.71	57.22	0.65	1.00	1.23		
												1.37	1.00	YES
First	R2	Residential	LKD	W2-L	0.78	0.92	1.61	56.50	98.97	0.65	0.15	0.17		
				W2-U	0.78	0.92	2.75	57.99	98.97	0.65	1.00	2.02		
												2.19	2.00	YES
Flat 31a														
First	R1	Residential	LKD	W1-L	0.78	0.92	1.61	88.54	101.42	0.65	0.15	0.26		
				W1-U	0.78	0.92	2.75	86.40	101.42	0.65	1.00	2.94		
				W2-L	0.78	0.92	0.62	76.99	101.42	0.65	0.15	0.09		
				W2-U	0.78	0.92	1.06	77.46	101.42	0.65	1.00	1.01		
				W3-L	0.78	0.92	0.62	73.69	101.42	0.65	0.15	0.08		
				W3-U	0.78	0.92	1.06	74.24	101.42	0.65	1.00	0.97		
												5.35	2.00	YES

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Flat 32														
First	R1	Residential	LD	W1-L	0.78	0.92	1.61	59.43	85.27	0.65	0.15	0.21	1.50	YES
				W1-U	0.78	0.92	2.75	44.67	85.27	0.65	1.00	1.80		
First	R2	Residential	Bedroom	W2-L	0.78	0.92	0.85	67.79	54.56	0.65	0.15	0.20	1.00	YES
				W2-U	0.78	0.92	1.45	69.25	54.56	0.65	1.00	2.30		
First	R3	Residential	Bedroom	W3-L	0.78	0.92	0.85	69.73	67.04	0.65	0.15	0.17	1.00	YES
				W3-U	0.78	0.92	1.45	70.85	67.04	0.65	1.00	1.91		
Flat 33														
First	R1	Residential	Bedroom	W1-L	0.78	0.92	0.85	70.81	62.83	0.65	0.15	0.18	1.00	YES
				W1-U	0.78	0.92	1.45	71.65	62.83	0.65	1.00	2.07		
First	R2	Residential	Bedroom	W2-L	0.78	0.92	0.85	69.37	48.60	0.65	0.15	0.23	1.00	YES
				W2-U	0.78	0.92	1.45	69.18	48.60	0.65	1.00	2.58		
First	R3	Residential	LD	W3-L	0.78	0.92	1.61	64.52	81.19	0.65	0.15	0.24	1.50	YES
				W3-U	0.78	0.92	2.75	49.21	81.19	0.65	1.00	2.09		
Flat 34														
First	R1	Residential	Bedroom	W1-L	0.78	0.92	0.85	72.23	60.79	0.65	0.15	0.19	1.00	YES
				W1-U	0.78	0.92	1.45	72.87	60.79	0.65	1.00	2.17		
First	R2	Residential	Bedroom	W2-L	0.78	0.92	0.85	71.93	58.34	0.65	0.15	0.20	1.00	YES
				W2-U	0.78	0.92	1.45	72.44	58.34	0.65	1.00	2.25		

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First	R3	Residential	LD	W3-L	0.78	0.92	1.61	65.32	86.32	0.65	0.15	0.23	1.50	YES
				W3-U	0.78	0.92	2.75	49.95	86.32	0.65	1.00	1.99		
				2.22										
Flat 35														
First	R1	Residential	LD	W1-L	0.78	0.92	1.61	66.02	85.77	0.65	0.15	0.23	1.50	YES
				W1-U	0.78	0.92	2.75	50.50	85.77	0.65	1.00	2.03		
				2.26										
First	R2	Residential	Bedroom	W2-L	0.78	0.92	0.85	73.75	60.65	0.65	0.15	0.19	1.00	YES
				W2-U	0.78	0.92	1.45	73.98	60.65	0.65	1.00	2.21		
				2.40										
First	R3	Residential	Bedroom	W3-L	0.78	0.92	0.85	75.30	72.30	0.65	0.15	0.17	1.00	YES
				W3-U	0.78	0.92	1.45	75.57	72.30	0.65	1.00	1.89		
				2.06										
Flat 36														
First	R1	Residential	LKD	W1-L	0.78	0.92	0.85	76.55	136.53	0.65	0.15	0.09	2.00	YES
				W1-U	0.78	0.92	1.45	76.60	136.53	0.65	1.00	1.02		
				W2-L	0.78	0.92	0.85	77.28	136.53	0.65	0.15	0.09		
				W2-U	0.78	0.92	1.45	77.23	136.53	0.65	1.00	1.02		
				W3-L	0.78	0.92	1.93	45.71	136.53	0.65	0.15	0.12		
				W3-U	0.78	0.92	3.29	26.31	136.53	0.65	1.00	0.79		
				W4-L	0.78	0.92	0.62	84.63	136.53	0.65	0.15	0.07		
				W4-U	0.78	0.92	1.06	83.44	136.53	0.65	1.00	0.81		
				4.01										
Flat 37														
Second	R1	Residential	LKD	W1-L	0.78	0.92	0.62	84.63	135.91	0.65	0.15	0.07	2.00	YES
				W1-U	0.78	0.92	1.06	83.44	135.91	0.65	1.00	0.81		
				W2-L	0.78	0.92	1.94	51.73	135.91	0.65	0.15	0.14		
				W2-U	0.78	0.92	3.31	38.78	135.91	0.65	1.00	1.18		

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				W3-L	0.78	0.92	0.85	80.53	135.91	0.65	0.15	0.09		
				W3-U	0.78	0.92	1.45	80.40	135.91	0.65	1.00	1.07		
				W4-L	0.78	0.92	0.85	80.04	135.91	0.65	0.15	0.09		
				W4-U	0.78	0.92	1.45	80.03	135.91	0.65	1.00	1.07		
												4.53	2.00	YES
Flat 38														
Second	R1	Residential	Bedroom	W1-L	0.78	0.92	0.85	79.34	70.49	0.65	0.15	0.18		
				W1-U	0.78	0.92	1.45	79.50	70.49	0.65	1.00	2.04		
												2.22	1.00	YES
Second	R2	Residential	Bedroom	W2-L	0.78	0.92	0.85	79.10	60.65	0.65	0.15	0.21		
				W2-U	0.78	0.92	1.45	79.32	60.65	0.65	1.00	2.37		
												2.58	1.00	YES
Second	R3	Residential	LD	W3-L	0.78	0.92	1.61	80.19	85.77	0.65	0.15	0.28		
				W3-U	0.78	0.92	2.75	80.06	85.77	0.65	1.00	3.22		
												3.50	1.50	YES
Flat 39														
Second	R1	Residential	LD	W1-L	0.78	0.92	1.61	79.67	86.32	0.65	0.15	0.28		
				W1-U	0.78	0.92	2.75	79.68	86.32	0.65	1.00	3.18		
												3.46	1.50	YES
Second	R2	Residential	Bedroom	W2-L	0.78	0.92	0.85	77.86	58.34	0.65	0.15	0.21		
				W2-U	0.78	0.92	1.45	78.37	58.34	0.65	1.00	2.43		
												2.65	1.00	YES
Second	R3	Residential	Bedroom	W3-L	0.78	0.92	0.85	77.31	60.79	0.65	0.15	0.20		
				W3-U	0.78	0.92	1.45	78.08	60.79	0.65	1.00	2.33		
												2.53	1.00	YES
Flat 40														
Second	R1	Residential	LD	W1-L	0.78	0.92	1.61	63.53	81.19	0.65	0.15	0.24		
				W1-U	0.78	0.92	2.75	33.51	81.19	0.65	1.00	1.42		

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												1.66	1.50	YES
Second	R2	Residential	Bedroom	W2-L	0.78	0.92	0.85	75.44	48.60	0.65	0.15	0.25		
				W2-U	0.78	0.92	1.45	76.67	48.60	0.65	1.00	2.86		
												3.11	1.00	YES
Second	R3	Residential	Bedroom	W3-L	0.78	0.92	0.86	76.29	62.83	0.65	0.15	0.20		
				W3-U	0.78	0.92	1.47	77.14	62.83	0.65	1.00	2.26		
												2.46	1.00	YES
Flat 41														
Second	R1	Residential	Bedroom	W1-L	0.78	0.92	0.85	75.45	65.60	0.65	0.15	0.18		
				W1-U	0.78	0.92	1.45	76.42	65.60	0.65	1.00	2.11		
												2.29	1.00	YES
Second	R2	Residential	Bedroom	W2-L	0.78	0.92	0.85	74.83	54.56	0.65	0.15	0.22		
				W2-U	0.78	0.92	1.45	75.92	54.56	0.65	1.00	2.52		
												2.74	1.00	YES
Second	R3	Residential	LD	W3-L	0.78	0.92	1.61	74.40	85.87	0.65	0.15	0.26		
				W3-U	0.78	0.92	2.75	75.44	85.87	0.65	1.00	3.03		
												3.29	1.50	YES
Flat 42														
Second	R1	Residential	LKD	W1-L	0.78	0.92	1.61	63.37	98.97	0.65	0.15	0.19		
				W1-U	0.78	0.92	2.75	66.35	98.97	0.65	1.00	2.31		
												2.50	2.00	YES
Second	R2	Residential	Bedroom	W2-L	0.78	0.92	0.85	57.44	57.23	0.65	0.15	0.16		
				W2-U	0.78	0.92	1.45	46.61	57.23	0.65	1.00	1.48		
												1.64	1.00	YES
Flat 43														
Second	R1	Residential	LKD	W1-L	0.78	0.92	0.62	79.66	120.64	0.65	0.15	0.08		
				W1-U	0.78	0.92	0.95	79.11	120.64	0.65	1.00	0.78		
				W2-L	0.78	0.92	1.93	52.36	120.64	0.65	0.15	0.16		

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				W2-U	0.78	0.92	2.97	39.87	120.64	0.65	1.00	1.23		
				W3-L	0.78	0.92	0.85	86.71	120.64	0.65	0.15	0.11		
				W3-U	0.78	0.92	1.45	85.15	120.64	0.65	1.00	1.28		
												3.64	2.00	YES
Flat 44														
Second	R1	Residential	LKD	W1-L	0.78	0.92	0.85	85.70	85.99	0.65	0.15	0.16		
				W1-U	0.78	0.92	1.45	84.88	85.99	0.65	1.00	1.79		
				W2-L	0.78	0.92	0.62	83.73	85.99	0.65	0.15	0.11		
				W2-U	0.78	0.92	1.06	83.19	85.99	0.65	1.00	1.28		
				W3-L	0.78	0.92	1.77	52.26	85.99	0.65	0.15	0.20		
				W3-U	0.78	0.92	3.02	40.50	85.99	0.65	1.00	1.78		
												5.33	2.00	YES
Second	R2	Residential	Bedroom	W4-L	0.78	0.92	0.62	51.52	58.31	0.65	0.15	0.10		
				W4-U	0.78	0.92	1.06	42.36	58.31	0.65	1.00	0.96		
												1.06	1.00	YES
Flat 45														
Second	R1	Residential	LKD	W1-L	0.78	0.92	0.85	58.43	103.97	0.65	0.15	0.09		
				W1-U	0.78	0.92	1.45	59.49	103.97	0.65	1.00	1.04		
				W2-L	0.78	0.92	0.85	52.97	103.97	0.65	0.15	0.08		
				W2-U	0.78	0.92	1.45	42.47	103.97	0.65	1.00	0.74		
												1.95	2.00	NO
Second	R2	Residential	Bedroom	W3-L	0.78	0.92	0.85	85.57	67.72	0.65	0.15	0.20		
				W3-U	0.78	0.92	1.45	84.85	67.72	0.65	1.00	2.27		
				W4-L	0.78	0.92	0.85	85.60	67.72	0.65	0.15	0.20		
				W4-U	0.78	0.92	1.45	84.85	67.72	0.65	1.00	2.27		
												4.94	1.00	YES
Second	R3	Residential	Bedroom	W5-L	0.78	0.92	0.85	85.63	57.24	0.65	0.15	0.24		
				W5-U	0.78	0.92	1.45	84.86	57.24	0.65	1.00	2.69		
												2.92	1.00	YES

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Flat 46														
Second	R1	Residential	LD	W1-L	0.78	0.92	1.61	65.81	86.87	0.65	0.15	0.23		
				W1-U	0.78	0.92	2.75	51.12	86.87	0.65	1.00	2.03		
												2.26	1.50	YES
Second	R2	Residential	Bedroom	W2-L	0.78	0.92	0.85	78.70	57.68	0.65	0.15	0.22		
				W2-U	0.78	0.92	1.45	80.10	57.68	0.65	1.00	2.52		
												2.73	1.00	YES
Second	R3	Residential	Bedroom	W3-L	0.78	0.92	0.62	83.05	63.56	0.65	0.15	0.15		
				W3-U	0.78	0.92	1.06	82.91	63.56	0.65	1.00	1.72		
				W4-L	0.78	0.92	0.85	85.44	63.56	0.65	0.15	0.21		
				W4-U	0.78	0.92	1.45	84.81	63.56	0.65	1.00	2.42		
												4.51	1.00	YES
Flat 47														
Second	R1	Residential	LKD	W1-L	0.78	0.92	0.85	72.92	99.05	0.65	0.15	0.12		
				W1-U	0.78	0.92	1.45	72.62	99.05	0.65	1.00	1.33		
				W2-L	0.78	0.92	1.61	68.00	99.05	0.65	0.15	0.21		
				W2-U	0.78	0.92	2.75	52.81	99.05	0.65	1.00	1.84		
												3.49	2.00	YES
Second	R2	Residential	Bedroom	W3-L	0.78	0.92	0.85	72.92	59.26	0.65	0.15	0.20		
				W3-U	0.78	0.92	1.45	72.62	59.26	0.65	1.00	2.22		
												2.42	1.00	YES
Flat 48														
Second	R1	Residential	LD	W1-L	0.78	0.92	1.61	65.81	86.87	0.65	0.15	0.23		
				W1-U	0.78	0.92	2.75	51.12	86.87	0.65	1.00	2.03		
												2.26	1.50	YES
Second	R2	Residential	Bedroom	W2-L	0.78	0.92	0.85	84.72	63.92	0.65	0.15	0.21		
				W2-U	0.78	0.92	1.45	84.61	63.92	0.65	1.00	2.40		
				W3-L	0.78	0.92	0.62	82.46	63.92	0.65	0.15	0.15		

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Second	R3	Residential	Bedroom	W3-U	0.78	0.92	1.06	82.74	63.92	0.65	1.00	1.71	1.00	YES
				W4-L	0.78	0.92	0.85	78.14	57.71	0.65	0.15	4.47		
				W4-U	0.78	0.92	1.45	79.88	57.71	0.65	1.00	2.51		
Flat 49														
Second	R1	Residential	LKD	W1-L	0.78	0.92	0.85	52.99	103.96	0.65	0.15	0.08		
				W1-U	0.78	0.92	1.45	42.49	103.96	0.65	1.00	0.74		
				W2-L	0.78	0.92	0.85	58.49	103.96	0.65	0.15	0.09		
				W2-U	0.78	0.92	1.45	59.54	103.96	0.65	1.00	1.04		
Second	R2	Residential	Bedroom	W3-L	0.78	0.92	0.85	84.33	57.26	0.65	0.15	0.23	2.00	NO
				W3-U	0.78	0.92	1.45	84.53	57.26	0.65	1.00	2.67		
												1.95		
Second	R3	Residential	Bedroom	W4-L	0.78	0.92	0.85	84.42	67.66	0.65	0.15	0.20	1.00	YES
				W4-U	0.78	0.92	1.45	84.55	67.66	0.65	1.00	2.26		
				W5-L	0.78	0.92	0.85	84.52	67.66	0.65	0.15	0.20		
				W5-U	0.78	0.92	1.45	84.58	67.66	0.65	1.00	2.26		
												4.93		
Flat 50														
Second	R1	Residential	Bedroom	W1-L	0.78	0.92	0.62	51.85	57.52	0.65	0.15	0.10		
				W1-U	0.78	0.92	1.06	42.96	57.52	0.65	1.00	0.99		
Second	R2	Residential	LKD									1.09	1.00	YES
				W2-L	0.78	0.92	1.77	52.06	85.99	0.65	0.15	0.20		
				W2-U	0.78	0.92	3.02	40.42	85.99	0.65	1.00	1.78		
				W3-L	0.78	0.92	0.62	82.29	85.99	0.65	0.15	0.11		
				W3-U	0.78	0.92	1.06	82.83	85.99	0.65	1.00	1.27		
				W4-L	0.78	0.92	0.85	84.24	85.99	0.65	0.15	0.16		
				W4-U	0.78	0.92	1.45	84.51	85.99	0.65	1.00	1.78		
												5.30	2.00	YES

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Flat 50a														
Second	R1	Residential	LKD	W1-L	0.78	0.92	0.62	77.93	101.55	0.65	0.15	0.09		
				W1-U	0.78	0.92	1.06	78.64	101.55	0.65	1.00	1.02		
				W2-L	0.78	0.92	0.62	80.87	101.55	0.65	0.15	0.09		
				W2-U	0.78	0.92	1.06	81.24	101.55	0.65	1.00	1.06		
				W3-L	0.78	0.92	1.61	88.59	101.55	0.65	0.15	0.26		
				W3-U	0.78	0.92	2.75	86.43	101.55	0.65	1.00	2.93		
												5.46	2.00	YES
Flat 51														
Second	R1	Residential	Bedroom	W1-L	0.78	0.92	0.85	57.41	57.22	0.65	0.15	0.16		
				W1-U	0.78	0.92	1.45	46.34	57.22	0.65	1.00	1.47		
												1.63	1.00	YES
Second	R2	Residential	LKD	W2-L	0.78	0.92	1.61	63.36	98.97	0.65	0.15	0.19		
				W2-U	0.78	0.92	2.75	66.37	98.97	0.65	1.00	2.31		
												2.50	2.00	YES
Flat 52														
Second	R1	Residential	LD	W1-L	0.78	0.92	1.61	74.41	85.26	0.65	0.15	0.26		
				W1-U	0.78	0.92	2.75	75.45	85.26	0.65	1.00	3.05		
												3.31	1.50	YES
Second	R2	Residential	Bedroom	W2-L	0.78	0.92	0.85	74.84	54.56	0.65	0.15	0.22		
				W2-U	0.78	0.92	1.45	75.93	54.56	0.65	1.00	2.52		
												2.74	1.00	YES
Second	R3	Residential	Bedroom	W3-L	0.78	0.92	0.85	75.47	67.04	0.65	0.15	0.18		
				W3-U	0.78	0.92	1.45	76.43	67.04	0.65	1.00	2.07		
												2.24	1.00	YES

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Flat 53														
Second	R1	Residential	Bedroom	W1-L	0.78	0.92	0.85	76.31	62.83	0.65	0.15	0.19		
				W1-U	0.78	0.92	1.45	77.15	62.83	0.65	1.00	2.23		
												2.42	1.00	YES
Second	R2	Residential	Bedroom	W2-L	0.78	0.92	0.85	75.46	48.60	0.65	0.15	0.25		
				W2-U	0.78	0.92	1.45	76.69	48.60	0.65	1.00	2.86		
												3.11	1.00	YES
Second	R3	Residential	LD	W3-L	0.78	0.92	1.61	63.55	81.19	0.65	0.15	0.24		
				W3-U	0.78	0.92	2.75	33.53	81.19	0.65	1.00	1.42		
												1.66	1.50	YES
Flat 54														
Second	R1	Residential	Bedroom	W1-L	0.78	0.92	0.85	77.33	60.79	0.65	0.15	0.20		
				W1-U	0.78	0.92	1.45	78.11	60.79	0.65	1.00	2.33		
												2.53	1.00	YES
Second	R2	Residential	Bedroom	W2-L	0.78	0.92	0.85	77.89	58.34	0.65	0.15	0.21		
				W2-U	0.78	0.92	1.45	78.40	58.34	0.65	1.00	2.43		
												2.65	1.00	YES
Second	R3	Residential	LD	W3-L	0.78	0.92	1.61	79.70	86.32	0.65	0.15	0.28		
				W3-U	0.78	0.92	2.75	79.71	86.32	0.65	1.00	3.18		
												3.46	1.50	YES
Flat 55														
Second	R1	Residential	LD	W1-L	0.78	0.92	1.61	80.21	85.77	0.65	0.15	0.28		
				W1-U	0.78	0.92	2.75	80.09	85.77	0.65	1.00	3.22		
												3.50	1.50	YES
Second	R2	Residential	Bedroom	W2-L	0.78	0.92	0.85	79.12	60.65	0.65	0.15	0.21		
				W2-U	0.78	0.92	1.45	79.34	60.65	0.65	1.00	2.37		
												2.58	1.00	YES

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Second	R3	Residential	Bedroom	W3-L	0.78	0.92	0.85	79.37	72.30	0.65	0.15	0.17	1.00	YES
				W3-U	0.78	0.92	1.45	79.52	72.30	0.65	1.00	1.99		
				2.17	1.00									
Flat 56														
Second	R1	Residential	LKD	W1-L	0.78	0.92	0.85	80.06	136.53	0.65	0.15	0.09	2.00	YES
				W1-U	0.78	0.92	1.45	80.05	136.53	0.65	1.00	1.06		
				W2-L	0.78	0.92	0.85	80.55	136.53	0.65	0.15	0.09		
				W2-U	0.78	0.92	1.45	80.42	136.53	0.65	1.00	1.07		
				W3-L	0.78	0.92	1.93	45.34	136.53	0.65	0.15	0.12		
				W3-U	0.78	0.92	3.29	22.65	136.53	0.65	1.00	0.68		
				W4-L	0.78	0.92	0.62	84.63	136.53	0.65	0.15	0.07		
				W4-U	0.78	0.92	1.06	83.44	136.53	0.65	1.00	0.81		
				4.00	2.00									
Flat 57														
Third	R1	Residential	LKD	W1-L	0.78	0.92	0.62	84.63	136.10	0.65	0.15	0.07	2.00	YES
				W1-U	0.78	0.92	1.06	83.44	136.10	0.65	1.00	0.81		
				W2-L	0.78	0.92	1.93	50.51	136.10	0.65	0.15	0.13		
				W2-U	0.78	0.92	3.29	35.09	136.10	0.65	1.00	1.06		
				W3-L	0.78	0.92	0.85	83.74	136.10	0.65	0.15	0.10		
				W3-U	0.78	0.92	1.45	83.46	136.10	0.65	1.00	1.11		
				W4-L	0.78	0.92	0.85	83.52	136.10	0.65	0.15	0.10		
				W4-U	0.78	0.92	1.45	83.35	136.10	0.65	1.00	1.11		
4.49	2.00													
Flat 58														
Third	R1	Residential	Bedroom	W1-L	0.78	0.92	1.14	54.15	75.50	0.65	0.15	0.15	1.00	YES
				W1-U	0.78	0.92	1.94	81.72	75.50	0.65	1.00	2.63		
2.78														

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Third	R2	Residential	LKD	W2-L	0.78	0.92	1.14	55.68	101.42	0.65	0.15	0.12	2.00	YES	
				W2-U	0.78	0.92	1.94	83.86	101.42	0.65	1.00	2.01			
				W3	0.78	0.84	0.32	N/A	101.42	0.70	1.00	0.67			
Flat 59															
Third	R1	Residential	LKD	W1-L	0.78	0.92	1.14	55.69	104.24	0.65	0.15	0.11	2.00	YES	
				W1-U	0.78	0.92	1.94	83.75	104.24	0.65	1.00	1.95			
				W2	0.78	0.84	0.32	N/A	104.24	0.71	1.00	0.66			
Third	R2	Residential	Bedroom	W3-L	0.78	0.92	1.14	54.36	75.63	0.65	0.15	0.15	1.00	YES	
				W3-U	0.78	0.92	1.94	81.97	75.63	0.65	1.00	2.63			
Flat 60															
Third	R1	Residential	LD	W1-L	0.78	0.92	1.61	83.75	82.06	0.65	0.15	0.31	1.50	YES	
				W1-U	0.78	0.92	2.75	83.75	82.06	0.65	1.00	3.52			
Third	R2	Residential	Bedroom	W2-L	0.78	0.92	0.85	81.95	48.79	0.65	0.15	0.27	1.00	YES	
				W2-U	0.78	0.92	1.45	82.47	48.79	0.65	1.00	3.06			
Third	R3	Residential	Bedroom	W3-L	0.78	0.92	0.85	81.78	65.58	0.65	0.15	0.20	1.00	YES	
				W3-U	0.78	0.92	1.45	82.37	65.58	0.65	1.00	2.28			
Flat 61															
Third	R1	Residential	Bedroom	W1-L	0.78	0.92	1.14	54.35	75.50	0.65	0.15	0.15	1.00	YES	
				W1-U	0.78	0.92	1.94	80.97	75.50	0.65	1.00	2.60			
Third	R2	Residential	LKD	W2-L	0.78	0.92	1.14	55.51	98.33	0.65	0.15	0.12	1.00	YES	
				W2-U	0.78	0.92	1.94	82.15	98.33	0.65	1.00	2.03			

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				W3	0.78	0.84	0.32	N/A	98.33	0.70	1.00	0.70		
												2.84	2.00	YES
Flat 62														
Third	R1	Residential	LKD	W1-L	0.78	0.92	1.61	77.82	101.83	0.65	0.15	0.23		
				W1-U	0.78	0.92	2.75	81.29	101.83	0.65	1.00	2.75		
												2.98	2.00	YES
Third	R2	Residential	Bedroom	W2-L	0.78	0.92	0.85	74.26	57.52	0.65	0.15	0.21		
				W2-U	0.78	0.92	1.45	77.89	57.52	0.65	1.00	2.45		
												2.66	1.00	YES
Flat 63														
Third	R1	Residential	LKD	W1-L	0.78	0.92	0.62	82.22	131.75	0.65	0.15	0.07		
				W1-U	0.78	0.92	1.06	82.06	131.75	0.65	1.00	0.82		
				W2-L	0.78	0.92	1.93	49.81	131.75	0.65	0.15	0.14		
				W2-U	0.78	0.92	3.29	33.10	131.75	0.65	1.00	1.03		
				W3-L	0.78	0.92	0.85	86.71	131.75	0.65	0.15	0.10		
				W3-U	0.78	0.92	1.45	85.15	131.75	0.65	1.00	1.17		
												3.34	2.00	YES
Flat 64														
Third	R1	Residential	LKD	W1-L	0.78	0.92	0.85	86.71	92.61	0.65	0.15	0.15		
				W1-U	0.78	0.92	1.45	85.15	92.61	0.65	1.00	1.67		
				W2-L	0.78	0.92	0.62	84.60	92.61	0.65	0.15	0.11		
				W2-U	0.78	0.92	1.06	83.44	92.61	0.65	1.00	1.20		
				W3-L	0.78	0.92	1.93	65.41	92.61	0.65	0.15	0.26		
				W3-U	0.78	0.92	3.29	69.58	92.61	0.65	1.00	3.09		
												6.47	2.00	YES
Third	R2	Residential	Bedroom	W4-L	0.78	0.92	0.62	60.46	64.48	0.65	0.15	0.11		
				W4-U	0.78	0.92	1.06	63.02	64.48	0.65	1.00	1.29		
												1.40	1.00	YES

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Flat 65														
Third	R1	Residential	LKD	W1-L	0.78	0.92	0.85	71.08	113.16	0.65	0.15	0.10		
				W1-U	0.78	0.92	1.45	76.37	113.16	0.65	1.00	1.22		
				W2-L	0.78	0.92	0.85	68.25	113.16	0.65	0.15	0.10		
				W2-U	0.78	0.92	1.45	72.95	113.16	0.65	1.00	1.17		
												2.59	2.00	YES
Third	R2	Residential	Bedroom	W3-L	0.78	0.92	0.85	86.71	74.43	0.65	0.15	0.19		
				W3-U	0.78	0.92	1.45	85.15	74.43	0.65	1.00	2.07		
				W4-L	0.78	0.92	0.85	86.71	74.43	0.65	0.15	0.19		
				W4-U	0.78	0.92	1.45	85.15	74.43	0.65	1.00	2.07		
												4.52	1.00	YES
Third	R3	Residential	Bedroom	W5-L	0.78	0.92	0.85	86.71	63.30	0.65	0.15	0.22		
				W5-U	0.78	0.92	1.45	85.15	63.30	0.65	1.00	2.44		
												2.66	1.00	YES
Flat 66														
Third	R1	Residential	LD	W1-L	0.78	0.92	1.61	82.30	96.30	0.65	0.15	0.26		
				W1-U	0.78	0.92	2.75	83.20	96.30	0.65	1.00	2.98		
												3.24	1.50	YES
Third	R2	Residential	Bedroom	W2-L	0.78	0.92	0.85	86.71	63.74	0.65	0.15	0.22		
				W2-U	0.78	0.92	1.45	85.15	63.74	0.65	1.00	2.42		
												2.64	1.00	YES
Third	R3	Residential	Bedroom	W3-L	0.78	0.92	0.62	84.63	70.59	0.65	0.15	0.14		
				W3-U	0.78	0.92	1.06	83.44	70.59	0.65	1.00	1.56		
				W4-L	0.78	0.92	0.85	86.71	70.59	0.65	0.15	0.20		
				W4-U	0.78	0.92	1.45	85.15	70.59	0.65	1.00	2.19		
												4.08	1.00	YES
Flat 67														
Third	R1	Residential	LKD	W1-L	0.78	0.92	0.85	81.85	108.42	0.65	0.15	0.12		

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				W1-U	0.78	0.92	1.45	82.51	108.42	0.65	1.00	1.38	2.00	YES
				W2-L	0.78	0.92	1.61	83.44	108.42	0.65	0.15	0.23		
				W2-U	0.78	0.92	2.75	83.67	108.42	0.65	1.00	2.66		
												4.39		
				W3-L	0.78	0.92	0.85	81.85	65.46	0.65	0.15	0.20		
				W3-U	0.78	0.92	1.45	82.51	65.46	0.65	1.00	2.28		
Third	R2	Residential	Bedroom									2.48	1.00	YES
Flat 68														
Third	R1	Residential	LD	W1-L	0.78	0.92	1.61	82.30	95.71	0.65	0.15	0.26	1.50	YES
				W1-U	0.78	0.92	2.75	83.20	95.71	0.65	1.00	3.00		
Third	R2	Residential	Bedroom									3.26	1.00	YES
				W2-L	0.78	0.92	0.85	86.71	70.59	0.65	0.15	0.20		
				W2-U	0.78	0.92	1.45	85.15	70.59	0.65	1.00	2.19		
				W3-L	0.78	0.92	0.62	84.63	70.59	0.65	0.15	0.14		
				W3-U	0.78	0.92	1.06	83.44	70.59	0.65	1.00	1.56		
Third	R3	Residential	Bedroom									4.08	1.00	YES
				W4-L	0.78	0.92	0.85	86.71	63.78	0.65	0.15	0.22		
				W4-U	0.78	0.92	1.45	85.15	63.78	0.65	1.00	2.42		
Flat 69														
Third	R1	Residential	LKD	W1-L	0.78	0.92	0.85	68.21	113.16	0.65	0.15	0.10	2.00	YES
				W1-U	0.78	0.92	1.45	72.86	113.16	0.65	1.00	1.17		
				W2-L	0.78	0.92	0.85	71.09	113.16	0.65	0.15	0.10		
				W2-U	0.78	0.92	1.45	76.34	113.16	0.65	1.00	1.22		
Third	R2	Residential	Bedroom									2.58	1.00	YES
				W3-L	0.78	0.92	0.85	86.71	63.32	0.65	0.15	0.22		
				W3-U	0.78	0.92	1.45	85.15	63.32	0.65	1.00	2.44		
Third	R3	Residential	Bedroom									2.65	1.00	YES
				W4-L	0.78	0.92	0.85	86.71	74.37	0.65	0.15	0.19		
				W4-U	0.78	0.92	1.45	85.15	74.37	0.65	1.00	2.07		

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				W5-L	0.78	0.92	0.85	86.71	74.37	0.65	0.15	0.19		
				W5-U	0.78	0.92	1.45	85.15	74.37	0.65	1.00	2.07		
												4.52	1.00	YES
Flat 70														
Third	R1	Residential	Bedroom	W1-L	0.78	0.92	0.62	62.23	64.44	0.65	0.15	0.11		
				W1-U	0.78	0.92	1.06	63.60	64.44	0.65	1.00	1.30		
												1.42	1.00	YES
Third	R2	Residential	LKD	W2-L	0.78	0.92	1.93	65.38	94.26	0.65	0.15	0.25		
				W2-U	0.78	0.92	3.29	69.56	94.26	0.65	1.00	3.04		
				W3-L	0.78	0.92	0.62	84.63	94.26	0.65	0.15	0.10		
				W3-U	0.78	0.92	1.06	83.44	94.26	0.65	1.00	1.17		
				W4-L	0.78	0.92	0.85	86.71	94.26	0.65	0.15	0.15		
				W4-U	0.78	0.92	1.45	85.15	94.26	0.65	1.00	1.64		
												6.34	2.00	YES
Flat 70a														
Third	R1	Residential	LKD	W1-L	0.78	0.92	0.62	81.51	111.11	0.65	0.15	0.09		
				W1-U	0.78	0.92	1.06	81.61	111.11	0.65	1.00	0.97		
				W2-L	0.78	0.92	0.62	83.37	111.11	0.65	0.15	0.09		
				W2-U	0.78	0.92	1.06	82.73	111.11	0.65	1.00	0.98		
				W3-L	0.78	0.92	1.51	88.59	111.11	0.65	0.15	0.23		
				W3-U	0.78	0.92	2.75	86.43	111.11	0.65	1.00	2.68		
												5.03	2.00	YES
Flat 71														
Third	R1	Residential	Bedroom	W1-L	0.78	0.92	0.83	74.11	63.41	0.65	0.15	0.18		
				W1-U	0.78	0.92	1.42	77.75	63.41	0.65	1.00	2.19		
												2.37	1.00	YES
Third	R2	Residential	LKD	W2-L	0.78	0.92	1.61	77.82	111.06	0.65	0.15	0.21		
				W2-U	0.78	0.92	2.75	81.29	111.06	0.65	1.00	2.52		

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												2.73	2.00	YES	
Flat 72															
Third	R1	Residential	LKD	W1-L	0.78	0.92	1.13	55.51	107.52	0.65	0.15	0.11	2.66	2.00	YES
				W1-U	0.78	0.92	1.93	82.16	107.52	0.65	1.00	1.85			
				W2	0.78	0.84	0.32	N/A	107.52	0.71	1.00	0.70			
Third	R2	Residential	Bedroom	W3-L	0.78	0.92	1.14	54.43	82.67	0.65	0.15	0.14	2.51	1.00	YES
				W3-U	0.78	0.92	1.93	81.10	82.67	0.65	1.00	2.37			
Flat 73															
Third	R1	Residential	Bedroom	W1-L	0.78	0.92	0.85	81.80	72.17	0.65	0.15	0.18	2.24	1.00	YES
				W1-U	0.78	0.92	1.44	82.38	72.17	0.65	1.00	2.06			
Third	R2	Residential	Bedroom	W2-L	0.78	0.92	0.85	81.97	54.00	0.65	0.15	0.24	3.00	1.00	YES
				W2-U	0.78	0.92	1.44	82.48	54.00	0.65	1.00	2.76			
Third	R3	Residential	LD	W3-L	0.78	0.92	1.61	83.78	88.86	0.65	0.15	0.29	3.53	1.50	YES
				W3-U	0.78	0.92	2.75	83.76	88.86	0.65	1.00	3.24			
Flat 74															
Third	R1	Residential	Bedroom	W1-L	0.78	0.92	1.14	53.71	82.80	0.65	0.15	0.14	2.51	1.00	YES
				W1-U	0.78	0.92	1.93	81.12	82.80	0.65	1.00	2.37			
Third	R2	Residential	LKD	W2-L	0.78	0.92	1.14	55.67	114.08	0.65	0.15	0.10	2.54	2.00	YES
				W2-U	0.78	0.92	1.93	83.75	114.08	0.65	1.00	1.78			
				W3	0.78	0.84	0.32	N/A	114.08	0.71	1.00	0.66			

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Flat 75														
Third	R1	Residential	LKD	W1-L	0.78	0.92	1.14	55.69	114.08	0.65	0.15	0.10		
				W1-U	0.78	0.92	1.93	83.89	114.08	0.65	1.00	1.78		
				W2	0.78	0.84	0.32	N/A	114.08	0.71	1.00	0.66		
												2.54	2.00	YES
Third	R2	Residential	Bedroom	W3-L	0.78	0.92	1.14	54.11	82.94	0.65	0.15	0.14		
				W3-U	0.78	0.92	1.93	81.78	82.94	0.65	1.00	2.39		
Flat 76														
Third	R1	Residential	LKD	W1	0.78	0.92	2.30	83.37	147.18	0.65	1.00	1.63		
				W2	0.78	0.92	2.30	83.47	147.18	0.65	1.00	1.63		
				W3-L	0.78	0.92	1.92	46.95	147.18	0.65	0.15	0.11		
				W3-U	0.78	0.92	3.27	30.85	147.18	0.65	1.00	0.86		
				W4-L	0.78	0.92	0.62	84.63	147.18	0.65	0.15	0.07		
				W4-U	0.78	0.92	1.06	83.44	147.18	0.65	1.00	0.75		
												5.05	2.00	YES

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Flat 1								
Ground	R1		Residential	Bedroom	Area m2 % of room	14.84	12.20 82%	YES
	R2		Residential	Bedroom	Area m2 % of room	11.88	10.76 91%	YES
	R3		Residential	LD	Area m2 % of room	19.96	15.01 75%	NO
Flat 2								
Ground	R1		Residential	LD	Area m2 % of room	20.23	15.02 74%	NO
	R2		Residential	Bedroom	Area m2 % of room	10.72	9.40 88%	YES
	R3		Residential	Bedroom	Area m2 % of room	11.48	10.48 91%	YES
Flat 3								
Ground	R1		Residential	LKD	Area m2 % of room	23.45	17.15 73%	NO
	R2		Residential	Bedroom	Area m2 % of room	15.17	12.94 85%	YES
Flat 4								
Ground	R1		Residential	Bedroom	Area m2 % of room	14.01	12.63 90%	YES
	R2		Residential	Bedroom	Area m2 % of room	10.26	9.41 92%	YES
	R3		Residential	LD	Area m2 % of room	19.87	15.07 76%	NO
Flat 5								
Ground	R1		Residential	LKD	Area m2 % of room	21.10	15.60 74%	NO
	R2		Residential	Bedroom	Area m2 % of room	12.84	9.21 72%	NO
Flat 6								
Ground	R1		Residential	LKD	Area m2 % of room	25.97	22.55 87%	YES
	R2		Residential	Bedroom	Area m2 % of room	14.82	14.68 99%	YES
	R3		Residential	Bedroom	Area m2 % of room	11.57	11.46 99%	YES
Flat 7								
Ground	R1		Residential	LD	Area m2 % of room	18.53	16.47 89%	YES
	R2		Residential	Bedroom	Area m2 % of room	11.75	11.58 98%	YES
	R3		Residential	Bedroom	Area m2 % of room	13.08	12.98 99%	YES

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Flat 8								
Ground	R1		Residential	LKD	Area m2 % of room	23.09	22.84 99%	YES
	R2		Residential	Bedroom	Area m2 % of room	12.17	11.94 98%	YES
Flat 9								
Ground	R1		Residential	LD	Area m2 % of room	18.53	16.44 89%	YES
	R2		Residential	Bedroom	Area m2 % of room	13.08	13.00 99%	YES
	R3		Residential	Bedroom	Area m2 % of room	11.75	11.56 98%	YES
Flat 10								
Ground	R1		Residential	LKD	Area m2 % of room	25.97	22.61 87%	YES
	R2		Residential	Bedroom	Area m2 % of room	11.57	11.46 99%	YES
	R3		Residential	Bedroom	Area m2 % of room	14.82	14.66 99%	YES
Flat 10a								
Ground	R1		Residential	LKD	Area m2 % of room	23.77	23.74 100%	YES
Flat 11								
Ground	R1		Residential	Bedroom	Area m2 % of room	12.88	9.20 71%	NO
	R2		Residential	LKD	Area m2 % of room	21.38	16.02 75%	NO
Flat 12								
Ground	R1		Residential	LD	Area m2 % of room	19.87	15.11 76%	NO
	R2		Residential	Bedroom	Area m2 % of room	10.26	9.44 92%	YES
	R3		Residential	Bedroom	Area m2 % of room	14.01	12.62 90%	YES
Flat 13								
Ground	R1		Residential	Bedroom	Area m2 % of room	14.96	13.03 87%	YES
	R2		Residential	LKD	Area m2 % of room	23.45	17.15 73%	NO
Flat 14								
Ground	R1		Residential	Bedroom	Area m2 % of room	11.48	10.64 93%	YES
	R2		Residential	Bedroom	Area m2 % of room	10.72	9.46 88%	YES

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	R3		Residential	LD	Area m2 % of room	20.23	15.08 75%	NO
Flat 15								
Ground	R1		Residential	LD	Area m2 % of room	19.96	15.02 75%	NO
	R2		Residential	Bedroom	Area m2 % of room	11.88	10.48 88%	YES
	R3		Residential	Bedroom	Area m2 % of room	15.74	12.24 78%	NO
Flat 16								
Ground	R1		Residential	LKD	Area m2 % of room	23.25	23.10 99%	YES
Flat 17								
First	R1		Residential	LKD	Area m2 % of room	28.75	28.57 99%	YES
Flat 18								
First	R1		Residential	Bedroom	Area m2 % of room	14.84	14.73 99%	YES
	R2		Residential	Bedroom	Area m2 % of room	11.88	11.69 98%	YES
	R3		Residential	LD	Area m2 % of room	19.96	19.92 100%	YES
Flat 19								
First	R1		Residential	LD	Area m2 % of room	20.23	20.22 100%	YES
	R2		Residential	Bedroom	Area m2 % of room	10.72	10.54 98%	YES
	R3		Residential	Bedroom	Area m2 % of room	11.48	11.38 99%	YES
Flat 20								
First	R1		Residential	LD	Area m2 % of room	18.92	18.83 100%	YES
	R2		Residential	Bedroom	Area m2 % of room	9.07	9.00 99%	YES
	R3		Residential	Bedroom	Area m2 % of room	12.16	11.96 98%	YES
Flat 21								
First	R1		Residential	Bedroom	Area m2 % of room	13.29	13.00 98%	YES
	R2		Residential	Bedroom	Area m2 % of room	10.26	10.16 99%	YES
	R3		Residential	LD	Area m2 % of room	20.25	20.21 100%	YES

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Flat 22								
First	R1		Residential	LKD	Area m2 % of room	24.60	24.27 99%	YES
	R2		Residential	Bedroom	Area m2 % of room	11.54	10.37 90%	YES
Flat 23								
First	R1		Residential	LKD	Area m2 % of room	28.00	27.89 100%	YES
Flat 24								
First	R1		Residential	Bedroom	Area m2 % of room	11.76	10.25 87%	YES
	R2		Residential	LKD	Area m2 % of room	19.68	19.66 100%	YES
Flat 25								
First	R1		Residential	LKD	Area m2 % of room	25.98	23.73 91%	YES
	R2		Residential	Bedroom	Area m2 % of room	14.83	14.69 99%	YES
	R3		Residential	Bedroom	Area m2 % of room	11.57	11.47 99%	YES
Flat 26								
First	R1		Residential	LD	Area m2 % of room	18.52	17.69 96%	YES
	R2		Residential	Bedroom	Area m2 % of room	11.74	11.57 99%	YES
	R3		Residential	Bedroom	Area m2 % of room	13.25	13.16 99%	YES
Flat 27								
First	R1		Residential	LKD	Area m2 % of room	23.09	22.91 99%	YES
	R2		Residential	Bedroom	Area m2 % of room	12.17	11.99 99%	YES
Flat 28								
First	R1		Residential	LD	Area m2 % of room	18.52	17.69 96%	YES
	R2		Residential	Bedroom	Area m2 % of room	13.25	13.18 99%	YES
	R3		Residential	Bedroom	Area m2 % of room	11.75	11.56 98%	YES
Flat 29								
First	R1		Residential	LKD	Area m2 % of room	25.97	23.77 92%	YES
	R2		Residential	Bedroom	Area m2 % of room	11.58	11.47 99%	YES

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Floor Ref.	Room Ref.	Room Attribute	Property Type	Room Use.		Room Area	Lit Area Proposed	Meets BRE Criteria
	R3		Residential	Bedroom	Area m2 % of room	14.83	14.69 99%	YES
Flat 30								
First	R1		Residential	Bedroom	Area m2 % of room	11.76	9.63 82%	YES
	R2		Residential	LKD	Area m2 % of room	19.68	19.66 100%	YES
Flat 31								
First	R1		Residential	Bedroom	Area m2 % of room	11.53	10.37 90%	YES
	R2		Residential	LKD	Area m2 % of room	24.60	24.27 99%	YES
Flat 31a								
First	R1		Residential	LKD	Area m2 % of room	23.77	23.73 100%	YES
Flat 32								
First	R1		Residential	LD	Area m2 % of room	19.95	19.87 100%	YES
	R2		Residential	Bedroom	Area m2 % of room	10.26	10.17 99%	YES
	R3		Residential	Bedroom	Area m2 % of room	14.01	13.73 98%	YES
Flat 33								
First	R1		Residential	Bedroom	Area m2 % of room	12.16	11.96 98%	YES
	R2		Residential	Bedroom	Area m2 % of room	9.07	8.98 99%	YES
	R3		Residential	LD	Area m2 % of room	18.96	18.90 100%	YES
Flat 34								
First	R1		Residential	Bedroom	Area m2 % of room	11.48	11.37 99%	YES
	R2		Residential	Bedroom	Area m2 % of room	10.72	10.52 98%	YES
	R3		Residential	LD	Area m2 % of room	20.23	20.21 100%	YES
Flat 35								
First	R1		Residential	LD	Area m2 % of room	19.96	19.91 100%	YES
	R2		Residential	Bedroom	Area m2 % of room	11.88	11.71 99%	YES
	R3		Residential	Bedroom	Area m2 % of room	15.74	15.65 99%	YES

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Floor Ref.	Room Ref.	Room Attribute	Property Type	Room Use.	Room Area	Lit Area Proposed	Meets BRE Criteria
Flat 36							
First	R1	Residential	LKD	Area m2 % of room	27.91	27.56 99%	YES
Flat 37							
Second	R1	Residential	LKD	Area m2 % of room	28.75	28.57 99%	YES
Flat 38							
Second	R1	Residential	Bedroom	Area m2 % of room	14.84	14.73 99%	YES
	R2	Residential	Bedroom	Area m2 % of room	11.88	11.69 98%	YES
	R3	Residential	LD	Area m2 % of room	19.96	19.92 100%	YES
Flat 39							
Second	R1	Residential	LD	Area m2 % of room	20.23	20.22 100%	YES
	R2	Residential	Bedroom	Area m2 % of room	10.72	10.55 98%	YES
	R3	Residential	Bedroom	Area m2 % of room	11.48	11.39 99%	YES
Flat 40							
Second	R1	Residential	LD	Area m2 % of room	18.96	18.90 100%	YES
	R2	Residential	Bedroom	Area m2 % of room	9.07	9.00 99%	YES
	R3	Residential	Bedroom	Area m2 % of room	12.16	11.96 98%	YES
Flat 41							
Second	R1	Residential	Bedroom	Area m2 % of room	13.29	13.02 98%	YES
	R2	Residential	Bedroom	Area m2 % of room	10.26	10.17 99%	YES
	R3	Residential	LD	Area m2 % of room	20.25	20.23 100%	YES
Flat 42							
Second	R1	Residential	LKD	Area m2 % of room	24.60	24.41 99%	YES
	R2	Residential	Bedroom	Area m2 % of room	11.54	11.39 99%	YES
Flat 43							
Second	R1	Residential	LKD	Area m2 % of room	28.00	27.87 100%	YES

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Floor Ref.	Room Ref.	Room Attribute	Property Type	Room Use.		Room Area	Lit Area Proposed	Meets BRE Criteria
Flat 44								
Second	R1		Residential	LKD	Area m2 % of room	19.68	19.66 100%	YES
	R2		Residential	Bedroom	Area m2 % of room	11.77	10.26 87%	YES
Flat 45								
Second	R1		Residential	LKD	Area m2 % of room	25.98	25.37 98%	YES
	R2		Residential	Bedroom	Area m2 % of room	14.85	14.71 99%	YES
	R3		Residential	Bedroom	Area m2 % of room	11.57	11.46 99%	YES
Flat 46								
Second	R1		Residential	LD	Area m2 % of room	18.52	18.39 99%	YES
	R2		Residential	Bedroom	Area m2 % of room	11.74	11.60 99%	YES
	R3		Residential	Bedroom	Area m2 % of room	13.07	12.99 99%	YES
Flat 47								
Second	R1		Residential	LKD	Area m2 % of room	23.09	23.00 100%	YES
	R2		Residential	Bedroom	Area m2 % of room	12.17	12.05 99%	YES
Flat 48								
Second	R1		Residential	LD	Area m2 % of room	18.52	18.35 99%	YES
	R2		Residential	Bedroom	Area m2 % of room	13.25	13.18 99%	YES
	R3		Residential	Bedroom	Area m2 % of room	11.75	11.60 99%	YES
Flat 49								
Second	R1		Residential	LKD	Area m2 % of room	25.97	25.36 98%	YES
	R2		Residential	Bedroom	Area m2 % of room	11.58	11.47 99%	YES
	R3		Residential	Bedroom	Area m2 % of room	14.83	14.69 99%	YES
Flat 50								
Second	R1		Residential	Bedroom	Area m2 % of room	11.61	8.84 76%	NO
	R2		Residential	LKD	Area m2 % of room	19.68	19.66 100%	YES

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Floor Ref.	Room Ref.	Room Attribute	Property Type	Room Use.	Room Area	Lit Area Proposed	Meets BRE Criteria
Flat 50a							
Second	R1		Residential	LKD	Area m2 % of room	23.81 23.79 100%	YES
Flat 51							
Second	R1		Residential	Bedroom	Area m2 % of room	11.53 11.37 99%	YES
	R2		Residential	LKD	Area m2 % of room	24.60 24.41 99%	YES
Flat 52							
Second	R1		Residential	LD	Area m2 % of room	19.95 19.90 100%	YES
	R2		Residential	Bedroom	Area m2 % of room	10.26 10.17 99%	YES
	R3		Residential	Bedroom	Area m2 % of room	14.01 13.74 98%	YES
Flat 53							
Second	R1		Residential	Bedroom	Area m2 % of room	12.16 11.95 98%	YES
	R2		Residential	Bedroom	Area m2 % of room	9.07 8.98 99%	YES
	R3		Residential	LD	Area m2 % of room	18.96 18.90 100%	YES
Flat 54							
Second	R1		Residential	Bedroom	Area m2 % of room	11.48 11.37 99%	YES
	R2		Residential	Bedroom	Area m2 % of room	10.72 10.53 98%	YES
	R3		Residential	LD	Area m2 % of room	20.23 20.21 100%	YES
Flat 55							
Second	R1		Residential	LD	Area m2 % of room	19.96 19.92 100%	YES
	R2		Residential	Bedroom	Area m2 % of room	11.88 11.72 99%	YES
	R3		Residential	Bedroom	Area m2 % of room	15.74 15.65 99%	YES
Flat 56							
Second	R1		Residential	LKD	Area m2 % of room	27.91 27.56 99%	YES
Flat 57							
Third	R1		Residential	LKD	Area m2 % of room	28.79 28.59 99%	YES

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Floor Ref.	Room Ref.	Room Attribute	Property Type	Room Use.		Room Area	Lit Area Proposed	Meets BRE Criteria
Flat 58								
Third	R1		Residential	Bedroom	Area m2 % of room	15.89	14.26 90%	YES
	R2		Residential	LKD	Area m2 % of room	23.24	22.11 95%	YES
Flat 59								
Third	R1		Residential	LKD	Area m2 % of room	23.18	22.06 95%	YES
	R2		Residential	Bedroom	Area m2 % of room	15.93	14.28 90%	YES
Flat 60								
Third	R1		Residential	LD	Area m2 % of room	19.26	19.20 100%	YES
	R2		Residential	Bedroom	Area m2 % of room	9.07	9.00 99%	YES
	R3		Residential	Bedroom	Area m2 % of room	13.42	13.21 98%	YES
Flat 61								
Third	R1		Residential	Bedroom	Area m2 % of room	15.89	14.25 90%	YES
	R2		Residential	LKD	Area m2 % of room	22.15	21.17 96%	YES
Flat 62								
Third	R1		Residential	LKD	Area m2 % of room	25.39	25.22 99%	YES
	R2		Residential	Bedroom	Area m2 % of room	11.46	11.21 98%	YES
Flat 63								
Third	R1		Residential	LKD	Area m2 % of room	28.04	27.90 99%	YES
Flat 64								
Third	R1		Residential	LKD	Area m2 % of room	19.29	19.08 99%	YES
	R2		Residential	Bedroom	Area m2 % of room	11.77	10.18 86%	YES
Flat 65								
Third	R1		Residential	LKD	Area m2 % of room	25.97	25.58 99%	YES
	R2		Residential	Bedroom	Area m2 % of room	14.84	14.68 99%	YES
	R3		Residential	Bedroom	Area m2 % of room	11.58	11.47 99%	YES

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


Floor Ref.	Room Ref.	Room Attribute	Property Type	Room Use.	Room Area	Lit Area Proposed	Meets BRE Criteria
Flat 66							
Third	R1	Residential	LD	Area m2 % of room	18.83	18.72 99%	YES
	R2	Residential	Bedroom	Area m2 % of room	11.74	11.58 99%	YES
	R3	Residential	Bedroom	Area m2 % of room	13.26	13.16 99%	YES
Flat 67							
Third	R1	Residential	LKD	Area m2 % of room	23.09	23.02 100%	YES
	R2	Residential	Bedroom	Area m2 % of room	12.17	12.06 99%	YES
Flat 68							
Third	R1	Residential	LD	Area m2 % of room	18.53	18.37 99%	YES
	R2	Residential	Bedroom	Area m2 % of room	13.26	13.16 99%	YES
	R3	Residential	Bedroom	Area m2 % of room	11.75	11.59 99%	YES
Flat 69							
Third	R1	Residential	LKD	Area m2 % of room	25.97	25.63 99%	YES
	R2	Residential	Bedroom	Area m2 % of room	11.58	11.48 99%	YES
	R3	Residential	Bedroom	Area m2 % of room	14.82	14.65 99%	YES
Flat 70							
Third	R1	Residential	Bedroom	Area m2 % of room	11.76	10.19 87%	YES
	R2	Residential	LKD	Area m2 % of room	19.68	19.67 100%	YES
Flat 70a							
Third	R1	Residential	LKD	Area m2 % of room	23.84	23.80 100%	YES
Flat 71							
Third	R1	Residential	Bedroom	Area m2 % of room	11.46	11.23 98%	YES
	R2	Residential	LKD	Area m2 % of room	25.66	25.52 99%	YES
Flat 72							
Third	R1	Residential	LKD	Area m2 % of room	22.15	21.15 95%	YES
	R2	Residential	Bedroom	Area m2 % of room	15.79	14.23 90%	YES

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
Floor Ref.	Room Ref.	Room Attribute	Property Type	Room Use.	Room Area	Lit Area Proposed	Meets BRE Criteria
Flat 73							
Third	R1		Residential	Bedroom	Area m2 % of room	13.42 13.24 99%	YES
	R2		Residential	Bedroom	Area m2 % of room	9.07 9.00 99%	YES
	R3		Residential	LD	Area m2 % of room	18.96 18.90 100%	YES
Flat 74							
Third	R1		Residential	Bedroom	Area m2 % of room	15.86 14.27 90%	YES
	R2		Residential	LKD	Area m2 % of room	23.18 22.06 95%	YES
Flat 75							
Third	R1		Residential	LKD	Area m2 % of room	23.18 22.05 95%	YES
	R2		Residential	Bedroom	Area m2 % of room	15.89 14.24 90%	YES
Flat 76							
Third	R1		Residential	LKD	Area m2 % of room	28.01 27.66 99%	YES

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Floor Ref.	Room Ref.	Property Type	Room Use.	Window Ref.	Window Orientation	Annual	Meets BRE Criteria	Winter	Meets BRE Criteria	Total Suns per Room Annual	Meets BRE Criteria	Total Suns per Room Winter	Meets BRE Criteria
Flat 1													
Ground	R1	Residential	Bedroom	W1	107°	53	YES	17	YES	53	YES	17	YES
	R2	Residential	Bedroom	W2	107°	52	YES	17	YES	52	YES	17	YES
	R3	Residential	LD	W3	107°	44	YES	17	YES	44	YES	17	YES
Flat 2													
Ground	R1	Residential	LD	W1	107°	40	YES	13	YES	40	YES	13	YES
	R2	Residential	Bedroom	W2	107°	39	YES	10	YES	39	YES	10	YES
	R3	Residential	Bedroom	W3	107°	47	YES	14	YES	47	YES	14	YES
Flat 3													
Ground	R1	Residential	LKD	W1	107°	40	YES	16	YES	44	YES	16	YES
				W2	107°	39	YES	12	YES				
	R2	Residential	Bedroom	W3	107°	45	YES	13	YES	45	YES	13	YES
Flat 4													
Ground	R1	Residential	Bedroom	W1	107°	50	YES	15	YES	50	YES	15	YES
	R2	Residential	Bedroom	W2	107°	50	YES	15	YES	50	YES	15	YES
	R3	Residential	LD	W3	107°	43	YES	17	YES	43	YES	17	YES
Flat 5													
Ground	R1	Residential	LKD	W1	107°	30	YES	6	YES	30	YES	6	YES
	R2	Residential	Bedroom	W2	107°	35	YES	12	YES	35	YES	12	YES
Flat 6													
Ground	R1	Residential	LKD	W1	197°	31	YES	15	YES	37	YES	18	YES
				W2	197°	28	YES	15	YES				
	R2	Residential	Bedroom	W3	17°N	10	NO	0	NO	12	NO	0	NO
				W4	17°N	12	NO	0	NO				
	R3	Residential	Bedroom	W5	17°N	12	NO	0	NO	12	NO	0	NO
Flat 7													
Ground	R1	Residential	LD	W1	197°	47	YES	17	YES	47	YES	17	YES
	R2	Residential	Bedroom	W2	17°N	2	NO	0	NO	2	NO	0	NO
	R3	Residential	Bedroom	W3	17°N	2	NO	0	NO	7	NO	0	NO
				W4	17°N	7	NO	0	NO				
Flat 8													
Ground	R1	Residential	LKD	W1	197°	48	YES	16	YES	60	YES	18	YES
				W2	197°	51	YES	17	YES				
	R2	Residential	Bedroom	W3	197°	58	YES	17	YES	58	YES	17	YES
Flat 9													
Ground	R1	Residential	LD	W1	197°	42	YES	14	YES	42	YES	14	YES
	R2	Residential	Bedroom	W2	17°N	11	NO	0	NO	11	NO	0	NO
				W3	17°N	11	NO	0	NO				
	R3	Residential	Bedroom	W4	17°N	11	NO	0	NO	11	NO	0	NO


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
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Floor Ref.	Room Ref.	Property Type	Room Use.	Window Ref.	Window Orientation	Annual	Meets BRE Criteria	Winter	Meets BRE Criteria	Total Suns per Room Annual	Meets BRE Criteria	Total Suns per Room Winter	Meets BRE Criteria								
Flat 10																					
Ground	R1	Residential	LKD	W1	197°	28	YES	11	YES	37	YES	11	YES								
				W2	196°	33	YES	8	YES												
	R2	Residential	Bedroom	W3	17°N	12	NO	0	NO					12	NO	0	NO				
				W4	17°N	11	NO	0	NO												
	R3	Residential	Bedroom	W5	17°N	11	NO	0	NO									11	NO	0	NO
Flat 10a																					
Ground	R1	Residential	LKD	W1	107°	60	YES	20	YES												
				W2	17°N	12	NO	0	NO												
				W3	17°N	12	NO	0	NO												
Flat 11																					
Ground	R1	Residential	Bedroom	W1	287°N	24	NO	4	NO	24	NO	4	NO								
	R2	Residential	LKD	W2	287°N	12	NO	0	NO												
Flat 12																					
Ground	R1	Residential	LD	W1	287°N	28	YES	6	YES	28	YES	6	YES								
	R2	Residential	Bedroom	W2	287°N	31	YES	8	YES												
	R3	Residential	Bedroom	W3	287°N	31	YES	8	YES												
Flat 13																					
Ground	R1	Residential	Bedroom	W1	287°N	26	YES	6	YES	26	YES	6	YES								
	R2	Residential	LKD	W2	287°N	21	NO	6	YES												
				W3	287°N	22	NO	7	YES												
Flat 14																					
Ground	R1	Residential	Bedroom	W1	287°N	27	YES	7	YES	27	YES	7	YES								
	R2	Residential	Bedroom	W2	287°N	26	YES	7	YES												
	R3	Residential	LD	W3	287°N	27	YES	7	YES												
Flat 15																					
Ground	R1	Residential	LD	W1	287°N	32	YES	10	YES	32	YES	10	YES								
	R2	Residential	Bedroom	W2	287°N	33	YES	10	YES												
	R3	Residential	Bedroom	W3	287°N	33	YES	10	YES												
Flat 16																					
Ground	R1	Residential	LKD	W1	287°N	38	YES	10	YES	86	YES	30	YES								
				W2	287°N	38	YES	10	YES												
				W3	197°	86	YES	30	YES												
Flat 17																					
First	R1	Residential	LKD	W1	197°	86	YES	30	YES	97	YES	30	YES								
				W2	107°	38	YES	16	YES												
				W3	107°	57	YES	18	YES												
				W4	107°	57	YES	18	YES												
Flat 18																					
First	R1	Residential	Bedroom	W1	107°	56	YES	17	YES	56	YES	17	YES								
	R2	Residential	Bedroom	W2	107°	55	YES	17	YES												
55																					

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Floor Ref.	Room Ref.	Property Type	Room Use.	Window Ref.	Window Orientation	Annual	Meets BRE Criteria	Winter	Meets BRE Criteria	Total Suns per Room Annual	Meets BRE Criteria	Total Suns per Room Winter	Meets BRE Criteria
	R3	Residential	LD	W3	107°	45	YES	18	YES	45	YES	18	YES
Flat 19													
First	R1	Residential	LD	W1	107°	41	YES	14	YES	41	YES	14	YES
	R2	Residential	Bedroom	W2	107°	50	YES	12	YES	50	YES	12	YES
	R3	Residential	Bedroom	W3	107°	54	YES	15	YES	54	YES	15	YES
Flat 20													
First	R1	Residential	LD	W1	107°	46	YES	18	YES	46	YES	18	YES
	R2	Residential	Bedroom	W2	107°	44	YES	13	YES	44	YES	13	YES
	R3	Residential	Bedroom	W3	107°	52	YES	15	YES	52	YES	15	YES
Flat 21													
First	R1	Residential	Bedroom	W1	107°	56	YES	17	YES	56	YES	17	YES
	R2	Residential	Bedroom	W2	107°	56	YES	18	YES	56	YES	18	YES
	R3	Residential	LD	W3	107°	43	YES	17	YES	43	YES	17	YES
Flat 22													
First	R1	Residential	LKD	W1	107°	33	YES	7	YES	33	YES	7	YES
	R2	Residential	Bedroom	W2	107°	37	YES	13	YES	37	YES	13	YES
Flat 23													
First	R1	Residential	LKD	W1	17°N	3	NO	0	NO	39	YES	10	YES
				W2	287°N	12	NO	1	NO				
				W3	287°N	38	YES	10	YES				
Flat 24													
First	R1	Residential	Bedroom	W4	17°N	2	NO	0	NO	2	NO	0	NO
	R2	Residential	LKD	W1	17°N	14	NO	0	NO				
				W2	17°N	14	NO	0	NO				
				W3	287°N	3	NO	0	NO	15	NO	0	NO
Flat 25													
First	R1	Residential	LKD	W1	197°	37	YES	18	YES	43	YES	19	YES
				W2	197°	28	YES	15	YES				
	R2	Residential	Bedroom	W3	17°N	11	NO	0	NO	13	NO	0	NO
				W4	17°N	13	NO	0	NO				
	R3	Residential	Bedroom	W5	17°N	13	NO	0	NO	13	NO	0	NO
Flat 26													
First	R1	Residential	LD	W1	197°	49	YES	21	YES	49	YES	21	YES
	R2	Residential	Bedroom	W2	17°N	1	NO	0	NO	1	NO	0	NO
	R3	Residential	Bedroom	W3	17°N	6	NO	0	NO	7	NO	0	NO
W4				17°N	7	NO	0	NO					
Flat 27													
First	R1	Residential	LKD	W1	197°	59	YES	23	YES	70	YES	23	YES
				W2	197°	55	YES	19	YES				
	R2	Residential	Bedroom	W3	197°	63	YES	18	YES	63	YES	18	YES

Project Name: Broadwater Road, Hertfordshire Project No.: 2405 Report Title: Daylight & Sunlight Analysis - Proposed Scheme Test Date of Analysis: 27/08/2019										<div><div>herrington</div><div>CONSULTING LIMITED</div></div>			
Floor Ref.	Room Ref.	Property Type	Room Use.	Window Ref.	Window Orientation	Annual	Meets BRE Criteria	Winter	Meets BRE Criteria	Total Suns per Room Annual	Meets BRE Criteria	Total Suns per Room Winter	Meets BRE Criteria
Flat 28													
First	R1	Residential	LD	W1	197°	52	YES	18	YES	52	YES	18	YES
	R2	Residential	Bedroom	W2	17°N	11	NO	0	NO				
				W3	17°N	11	NO	0	NO				
	R3	Residential	Bedroom	W4	17°N	11	NO	0	NO	11	NO	0	NO
	Flat 29												
First	R1	Residential	LKD	W1	197°	29	YES	12	YES	41	YES	13	YES
			W2	197°	37	YES	12	YES					
	R2	Residential	Bedroom	W3	17°N	12	NO	0	NO	12	NO	0	NO
	R3	Residential	Bedroom	W4	17°N	12	NO	0	NO	12	NO	0	NO
				W5	17°N	12	NO	0	NO				
Flat 30													
First	R1	Residential	Bedroom	W1	18°N	13	NO	0	NO	13	NO	0	NO
	R2	Residential	LKD	W2	107°	18	NO	2	NO				
				W3	17°N	13	NO	0	NO				
				W4	17°N	13	NO	0	NO	19	NO	2	NO
	Flat 31												
First	R1	Residential	Bedroom	W1	287°N	29	YES	5	YES	29	YES	5	YES
	R2	Residential	LKD	W2	287°N	16	NO	1	NO	16	NO	1	NO
Flat 31a													
First	R1	Residential	LKD	W1	107°	60	YES	20	YES	60	YES	20	YES
				W2	18°N	13	NO	0	NO				
				W3	18°N	13	NO	0	NO				
Flat 32													
First	R1	Residential	LD	W1	287°N	31	YES	8	YES	31	YES	8	YES
	R2	Residential	Bedroom	W2	287°N	35	YES	9	YES	35	YES	9	YES
	R3	Residential	Bedroom	W3	287°N	36	YES	9	YES	36	YES	9	YES
Flat 33													
First	R1	Residential	Bedroom	W1	287°N	31	YES	7	YES	31	YES	7	YES
	R2	Residential	Bedroom	W2	287°N	22	NO	7	YES	22	NO	7	YES
	R3	Residential	LD	W3	287°N	31	YES	9	YES	31	YES	9	YES
Flat 34													
First	R1	Residential	Bedroom	W1	287°N	34	YES	8	YES	34	YES	8	YES
	R2	Residential	Bedroom	W2	287°N	30	YES	7	YES	30	YES	7	YES
	R3	Residential	LD	W3	287°N	31	YES	8	YES	31	YES	8	YES
Flat 35													
First	R1	Residential	LD	W1	287°N	33	YES	10	YES	33	YES	10	YES
	R2	Residential	Bedroom	W2	287°N	35	YES	10	YES	35	YES	10	YES
	R3	Residential	Bedroom	W3	287°N	35	YES	10	YES	35	YES	10	YES

Project Name: Broadwater Road, Hertfordshire Project No.: 2405 Report Title: Daylight & Sunlight Analysis - Proposed Scheme Test Date of Analysis: 27/08/2019													
Floor Ref.	Room Ref.	Property Type	Room Use.	Window Ref.	Window Orientation	Annual	Meets BRE Criteria	Winter	Meets BRE Criteria	Total Suns per Room Annual	Meets BRE Criteria	Total Suns per Room Winter	Meets BRE Criteria
Flat 36													
First	R1	Residential	LKD	W1	287°N	36	YES	10	YES	86	YES	30	YES
				W2	287°N	38	YES	10	YES				
				W3	287°N	15	NO	8	YES				
				W4	197°	86	YES	30	YES				
Flat 37													
Second	R1	Residential	LKD	W1	197°	86	YES	30	YES	98	YES	30	YES
				W2	107°	38	YES	16	YES				
				W3	107°	59	YES	19	YES				
				W4	107°	59	YES	19	YES				
Flat 38													
Second	R1	Residential	Bedroom	W1	107°	58	YES	18	YES	58	YES	18	YES
	R2	Residential	Bedroom	W2	107°	58	YES	18	YES	58	YES	18	YES
	R3	Residential	LD	W3	107°	59	YES	19	YES	59	YES	19	YES
Flat 39													
Second	R1	Residential	LD	W1	107°	58	YES	19	YES	58	YES	19	YES
	R2	Residential	Bedroom	W2	107°	58	YES	19	YES	58	YES	19	YES
	R3	Residential	Bedroom	W3	107°	58	YES	19	YES	58	YES	19	YES
Flat 40													
Second	R1	Residential	LD	W1	107°	30	YES	15	YES	30	YES	15	YES
	R2	Residential	Bedroom	W2	107°	52	YES	13	YES	52	YES	13	YES
	R3	Residential	Bedroom	W3	107°	56	YES	17	YES	56	YES	17	YES
Flat 41													
Second	R1	Residential	Bedroom	W1	107°	57	YES	18	YES	57	YES	18	YES
	R2	Residential	Bedroom	W2	107°	57	YES	18	YES	57	YES	18	YES
	R3	Residential	LD	W3	107°	58	YES	19	YES	58	YES	19	YES
Flat 42													
Second	R1	Residential	LKD	W1	107°	36	YES	8	YES	36	YES	8	YES
	R2	Residential	Bedroom	W2	107°	42	YES	16	YES	42	YES	16	YES
Flat 43													
Second	R1	Residential	LKD	W1	17°N	3	NO	0	NO	39	YES	10	YES
				W2	287°N	12	NO	1	NO				
				W3	287°N	38	YES	10	YES				
Flat 44													
Second	R1	Residential	LKD	W1	17°N	14	NO	0	NO	16	NO	0	NO
				W2	17°N	14	NO	0	NO				
				W3	287°N	4	NO	0	NO				
	R2	Residential	Bedroom	W4	17°N	1	NO	0	NO				
Flat 45													
Second	R1	Residential	LKD	W1	197°	45	YES	19	YES	52	YES	20	YES
				W2	197°	35	YES	16	YES				
	R2	Residential	Bedroom	W3	17°N	13	NO	0	NO				

Project Name: Broadwater Road, Hertfordshire Project No.: 2405 Report Title: Daylight & Sunlight Analysis - Proposed Scheme Test Date of Analysis: 27/08/2019													
Floor Ref.	Room Ref.	Property Type	Room Use.	Window Ref.	Window Orientation	Annual	Meets BRE Criteria	Winter	Meets BRE Criteria	Total Suns per Room Annual	Meets BRE Criteria	Total Suns per Room Winter	Meets BRE Criteria
				W4	17°N	13	NO	0	NO				
	R3	Residential	Bedroom	W5	17°N	13	NO	0	NO	13	NO	0	NO
										13	NO	0	NO
Flat 46													
Second	R1	Residential	LD	W1	197°	58	YES	23	YES				
	R2	Residential	Bedroom	W2	17°N	2	NO	0	NO	58	YES	23	YES
	R3	Residential	Bedroom	W3	17°N	10	NO	0	NO	2	NO	0	NO
				W4	17°N	12	NO	0	NO				
										12	NO	0	NO
Flat 47													
Second	R1	Residential	LKD	W1	197°	62	YES	25	YES				
				W2	197°	65	YES	25	YES				
	R2	Residential	Bedroom	W3	197°	75	YES	25	YES	77	YES	26	YES
										75	YES	25	YES
Flat 48													
Second	R1	Residential	LD	W1	197°	62	YES	22	YES				
	R2	Residential	Bedroom	W2	17°N	12	NO	0	NO	62	YES	22	YES
				W3	17°N	12	NO	0	NO				
	R3	Residential	Bedroom	W4	17°N	12	NO	0	NO	12	NO	0	NO
										12	NO	0	NO
Flat 49													
Second	R1	Residential	LKD	W1	197°	41	YES	18	YES				
				W2	197°	46	YES	16	YES				
	R2	Residential	Bedroom	W3	17°N	13	NO	0	NO	56	YES	19	YES
	R3	Residential	Bedroom	W4	17°N	13	NO	0	NO	13	NO	0	NO
				W5	17°N	13	NO	0	NO				
										13	NO	0	NO
Flat 50													
Second	R1	Residential	Bedroom	W1	18°N	13	NO	0	NO				
	R2	Residential	LKD	W2	107°	19	NO	2	NO	13	NO	0	NO
				W3	17°N	13	NO	0	NO				
				W4	17°N	13	NO	0	NO				
										20	NO	2	NO
Flat 50a													
Second	R1	Residential	LKD	W1	18°N	13	NO	0	NO				
				W2	18°N	13	NO	0	NO				
				W3	107°	60	YES	20	YES				
										60	YES	20	YES
Flat 51													
Second	R1	Residential	Bedroom	W1	287°N	34	YES	8	YES				
	R2	Residential	LKD	W2	287°N	19	NO	1	NO	34	YES	8	YES
										19	NO	1	NO
Flat 52													
Second	R1	Residential	LD	W1	287°N	35	YES	8	YES				
	R2	Residential	Bedroom	W2	287°N	36	YES	9	YES	35	YES	8	YES
	R3	Residential	Bedroom	W3	287°N	36	YES	9	YES	36	YES	9	YES
										36	YES	9	YES
Flat 53													
Second	R1	Residential	Bedroom	W1	287°N	36	YES	9	YES				
	R2	Residential	Bedroom	W2	287°N	33	YES	5	YES	36	YES	9	YES
										33	YES	5	YES

Project Name: Broadwater Road, Hertfordshire Project No.: 2405 Report Title: Daylight & Sunlight Analysis - Proposed Scheme Test Date of Analysis: 27/08/2019										<div><div>herrington</div><div>CONSULTING LIMITED</div></div>			
Floor Ref.	Room Ref.	Property Type	Room Use.	Window Ref.	Window Orientation	Annual	Meets BRE Criteria	Winter	Meets BRE Criteria	Total Suns per Room Annual	Meets BRE Criteria	Total Suns per Room Winter	Meets BRE Criteria
	R3	Residential	LD	W3	287°N	20	NO	9	YES	20	NO	9	YES
Flat 54													
Second	R1	Residential	Bedroom	W1	287°N	36	YES	9	YES	36	YES	9	YES
	R2	Residential	Bedroom	W2	287°N	36	YES	9	YES	36	YES	9	YES
	R3	Residential	LD	W3	287°N	38	YES	10	YES	38	YES	10	YES
Flat 55													
Second	R1	Residential	LD	W1	287°N	37	YES	10	YES	37	YES	10	YES
	R2	Residential	Bedroom	W2	287°N	37	YES	10	YES	37	YES	10	YES
	R3	Residential	Bedroom	W3	287°N	37	YES	10	YES	37	YES	10	YES
Flat 56													
Second	R1	Residential	LKD	W1	287°N	37	YES	10	YES		YES	30	YES
				W2	287°N	39	YES	10	YES				
				W3	287°N	12	NO	7	YES				
				W4	197°	86	YES	30	YES				
Flat 57													
Third	R1	Residential	LKD	W1	196°	85	YES	30	YES		YES	30	YES
				W2	107°	30	YES	17	YES				
				W3	107°	60	YES	20	YES				
				W4	107°	60	YES	20	YES				
Flat 58													
Third	R1	Residential	Bedroom	W1	107°	53	YES	14	YES	53	YES	14	YES
	R2	Residential	LKD	W2	107°	58	YES	18	YES	100	YES	30	YES
				W3	106° Inc	100	YES	30	YES				
Flat 59													
Third	R1	Residential	LKD	W1	107°	60	YES	20	YES	100	YES	30	YES
				W2	106° Inc	100	YES	30	YES				
	R2	Residential	Bedroom	W3	107°	60	YES	20	YES				
Flat 60													
Third	R1	Residential	LD	W1	107°	60	YES	20	YES	60	YES	20	YES
	R2	Residential	Bedroom	W2	107°	60	YES	20	YES	60	YES	20	YES
				R3	Residential	Bedroom	W3	107°	60	YES	20	YES	
Flat 61													
Third	R1	Residential	Bedroom	W1	107°	53	YES	14	YES	53	YES	14	YES
	R2	Residential	LKD	W2	107°	57	YES	18	YES	100	YES	30	YES
				W3	106° Inc	100	YES	30	YES				
Flat 62													
Third	R1	Residential	LKD	W1	106°	57	YES	18	YES	57	YES	18	YES
	R2	Residential	Bedroom	W2	106°	58	YES	20	YES	58	YES	20	YES
Flat 63													
Third	R1	Residential	LKD	W1	17°N	9	NO	0	NO				
				W2	287°N	10	NO	1	NO				
				W3	286°N	38	YES	10	YES				

Project Name: Broadwater Road, Hertfordshire Project No.: 2405 Report Title: Daylight & Sunlight Analysis - Proposed Scheme Test Date of Analysis: 27/08/2019										<div><div>herrington</div><div>CONSULTING LIMITED</div></div>			
Floor Ref.	Room Ref.	Property Type	Room Use.	Window Ref.	Window Orientation	Annual	Meets BRE Criteria	Winter	Meets BRE Criteria	Total Suns per Room Annual	Meets BRE Criteria	Total Suns per Room Winter	Meets BRE Criteria
										45	YES	10	YES
Flat 64													
Third	R1	Residential	LKD	W1	17°N	14	NO	0	NO	22	NO	0	NO
				W2	17°N	14	NO	0	NO				
				W3	287°N	10	NO	0	NO				
	R2	Residential	Bedroom	W4	17°N	2	NO	0	NO	2	NO	0	NO
Flat 65													
Third	R1	Residential	LKD	W1	197°	68	YES	23	YES	71	YES	23	YES
				W2	197°	58	YES	19	YES				
	R2	Residential	Bedroom	W3	17°N	13	NO	0	NO				
				W4	17°N	13	NO	0	NO	13	NO	0	NO
	R3	Residential	Bedroom	W5	17°N	14	NO	0	NO	14	NO	0	NO
Flat 66													
Third	R1	Residential	LD	W1	197°	83	YES	29	YES	83	YES	29	YES
	R2	Residential	Bedroom	W2	17°N	13	NO	0	NO	13	NO	0	NO
	R3	Residential	Bedroom	W3	17°N	13	NO	0	NO	13	NO	0	NO
W4				17°N	13	NO	0	NO					
Flat 67													
Third	R1	Residential	LKD	W1	197°	84	YES	30	YES	84	YES	30	YES
				W2	197°	84	YES	30	YES				
	R2	Residential	Bedroom	W3	197°	85	YES	29	YES	85	YES	29	YES
Flat 68													
Third	R1	Residential	LD	W1	197°	84	YES	28	YES	84	YES	28	YES
	R2	Residential	Bedroom	W2	17°N	13	NO	0	NO	13	NO	0	NO
				W3	17°N	13	NO	0	NO				
	R3	Residential	Bedroom	W4	17°N	13	NO	0	NO	13	NO	0	NO
Flat 69													
Third	R1	Residential	LKD	W1	197°	66	YES	25	YES	76	YES	27	YES
				W2	197°	67	YES	23	YES				
	R2	Residential	Bedroom	W3	17°N	13	NO	0	NO	13	NO	0	NO
	R3	Residential	Bedroom	W4	17°N	13	NO	0	NO	13	NO	0	NO
				W5	17°N	13	NO	0	NO				
Flat 70													
Third	R1	Residential	Bedroom	W1	17°N	12	NO	0	NO	12	NO	0	NO
	R2	Residential	LKD	W2	107°	33	YES	2	NO	34	YES	2	NO
				W3	17°N	13	NO	0	NO				
W4				17°N	13	NO	0	NO					
Flat 70a													
Third	R1	Residential	LKD	W1	17°N	12	NO	0	NO	60	YES	20	YES
				W2	17°N	12	NO	0	NO				
				W3	107°	60	YES	20	YES				
Flat 71													
Third	R1	Residential	Bedroom	W1	287°N	40	YES	10	YES	40	YES	10	YES
	R2	Residential	LKD	W2	287°N	40	YES	10	YES				

Project Name: Broadwater Road, Hertfordshire Project No.: 2405 Report Title: Daylight & Sunlight Analysis - Proposed Scheme Test Date of Analysis: 27/08/2019										<div><div>herrington</div><div>CONSULTING LIMITED</div></div>			
Floor Ref.	Room Ref.	Property Type	Room Use.	Window Ref.	Window Orientation	Annual	Meets BRE Criteria	Winter	Meets BRE Criteria	Total Suns per Room Annual	Meets BRE Criteria	Total Suns per Room Winter	Meets BRE Criteria
										40	YES	10	YES
Flat 72													
Third	R1	Residential	LKD	W1	287°N	40	YES	10	YES	100	YES	30	YES
				W2	287°N	100	YES	30	YES				
	R2	Residential	Bedroom	W3	287°N	36	YES	6	YES				
										36	YES	6	YES
Flat 73													
Third	R1	Residential	Bedroom	W1	287°N	38	YES	10	YES	38	YES	10	YES
	R2	Residential	Bedroom	W2	287°N	38	YES	10	YES				
	R3	Residential	LD	W3	287°N	38	YES	10	YES				
										38	YES	10	YES
Flat 74													
Third	R1	Residential	Bedroom	W1	287°N	40	YES	10	YES	40	YES	10	YES
	R2	Residential	LKD	W2	287°N	40	YES	10	YES				
				W3	287°N	100	YES	30	YES				
										100	YES	30	YES
Flat 75													
Third	R1	Residential	LKD	W1	287°N	39	YES	9	YES	100	YES	30	YES
				W2	287°N	100	YES	30	YES				
	R2	Residential	Bedroom	W3	287°N	34	YES	6	YES				
										34	YES	6	YES
Flat 76													
Third	R1	Residential	LKD	W1	287°N	38	YES	10	YES				
				W2	287°N	38	YES	10	YES				
				W3	287°N	17	NO	8	YES				
				W4	197°	86	YES	30	YES				
										88	YES	30	YES

Project Name: Broadwater Road, Hertfordshire
Project No.: 2405
Report Title: Two hours Sunlight to Amenity Analysis - Proposed Scheme Test
Date: 27/08/2019

Floor Ref.	Amenity Ref.	Amenity Area	Lit Area Proposed	Meets BRE Criteria
Proposed Development				
Ground	Amenity Area	Area m2 Percentage	594.73 594.73 100%	YES