

Notes
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Materials Prohibited

Materials prohibited from use, except where used in accordance with 'Good Practice in the Selection of Construction Materials (March 2017)' or unless required by the Contract:

- high alumina cement in the structural elements;
- wood wool slabs in permanent formwork to concrete;
- calcium chloride admixtures for use in reinforced concrete;
- asbestos or asbestos-containing products, as defined in the 'Control of Asbestos at Work Regulations, as amended 2012' or any other statutory modification or re-enactment thereof;
- any naturally occurring or man made mineral fibres (for example, rock-wool or slag wool) with a thickness of 3 microns or less and a length of 200 microns or less, unless they are appropriately sealed to prevent migration of fibres;
- aggregates for use in reinforced concrete which do not comply with:
 - BS EN 12620:2002 properties of aggregates used in concrete;
 - BS EN 12620:2002 Properties of aggregates used in mortar;
 - BS EN 12620:2002 Properties of lightweight aggregates;
 - BS EN 12620:2002 Properties of lightweight aggregates;
 - BS EN 12620:2002 Properties of lightweight aggregates;
 - BS EN 12620:2002 Properties of lightweight aggregates;
- lead, lead paint or any other material containing lead which may be ingested, inhaled or absorbed, except where copper alloy fittings also containing lead are specifically required in drinking water pipework by any relevant statutory requirement or where lead flashings or other lead roof coverings are specifically provided for in the Contract; urea formaldehyde foam or materials which may release formaldehyde in quantities which may be hazardous with reference to the limits set by the Health and Safety Executive;
- calcium silicate bricks or tiles;
- vermiculite unless it is established as being fibre-free; calcium silicate bricks or tiles;
- any products containing cadmium referred to in Statutory Instrument SI 2006/3311
- Control of dangerous substances and preparation Regulations 2006. Reference should also be made to HSE ICG391 Cadmium and you;
- any new timber treated with pentachlorophenol;
- any non galvanised mild steel structural fittings for building elements particularly susceptible to corrosion;
- concrete used in circumstances where it is susceptible to alkali/silica reaction;
- materials containing chlorofluorocarbons (CFC's);
- solvent based paints except where water based paints are unsuitable for unavailability;
- any new materials not in accordance with statutory requirements, British Standards, Codes of Practice and good building practice current at the date of incorporation of the relevant materials into the works or the specifications thereof.

NOTES

- Scheme design subject to relevant Statutory Approvals.
- Scheme to be read in conjunction with elevation drawings and site plan.
- Scheme layout as instructed by Client.

KEY

E/S En-Suite
 N/S Nurse's Station
 AWC Assisted WC
 VWC Visitor's WC
 KF Kitchen Flue

ACCOMMODATION

GIA	1490m ²
UNIT 1 - 15 BED UNIT	
Dayspace	8.2m ² /Bed
UNIT 2 - 12 BED UNIT	
Dayspace	8m ² /Bed

NON-MATERIAL AMENDMENT APPLICATION

B	Revised as per Client's comments.	MP	06.04.2021
A	'Do Not Scale' notation omitted.	MP	17.01.2019
*	First Issue	MP	20.12.2018



Client
 Marbrook

Project
 Broadwater Road
 Welwyn Garden City, AL7 3AX

Title
 Ground Floor Identification Plan

Scale
 1:100@A1

Date
 03.08.2018

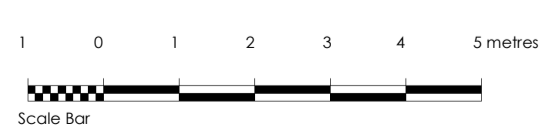
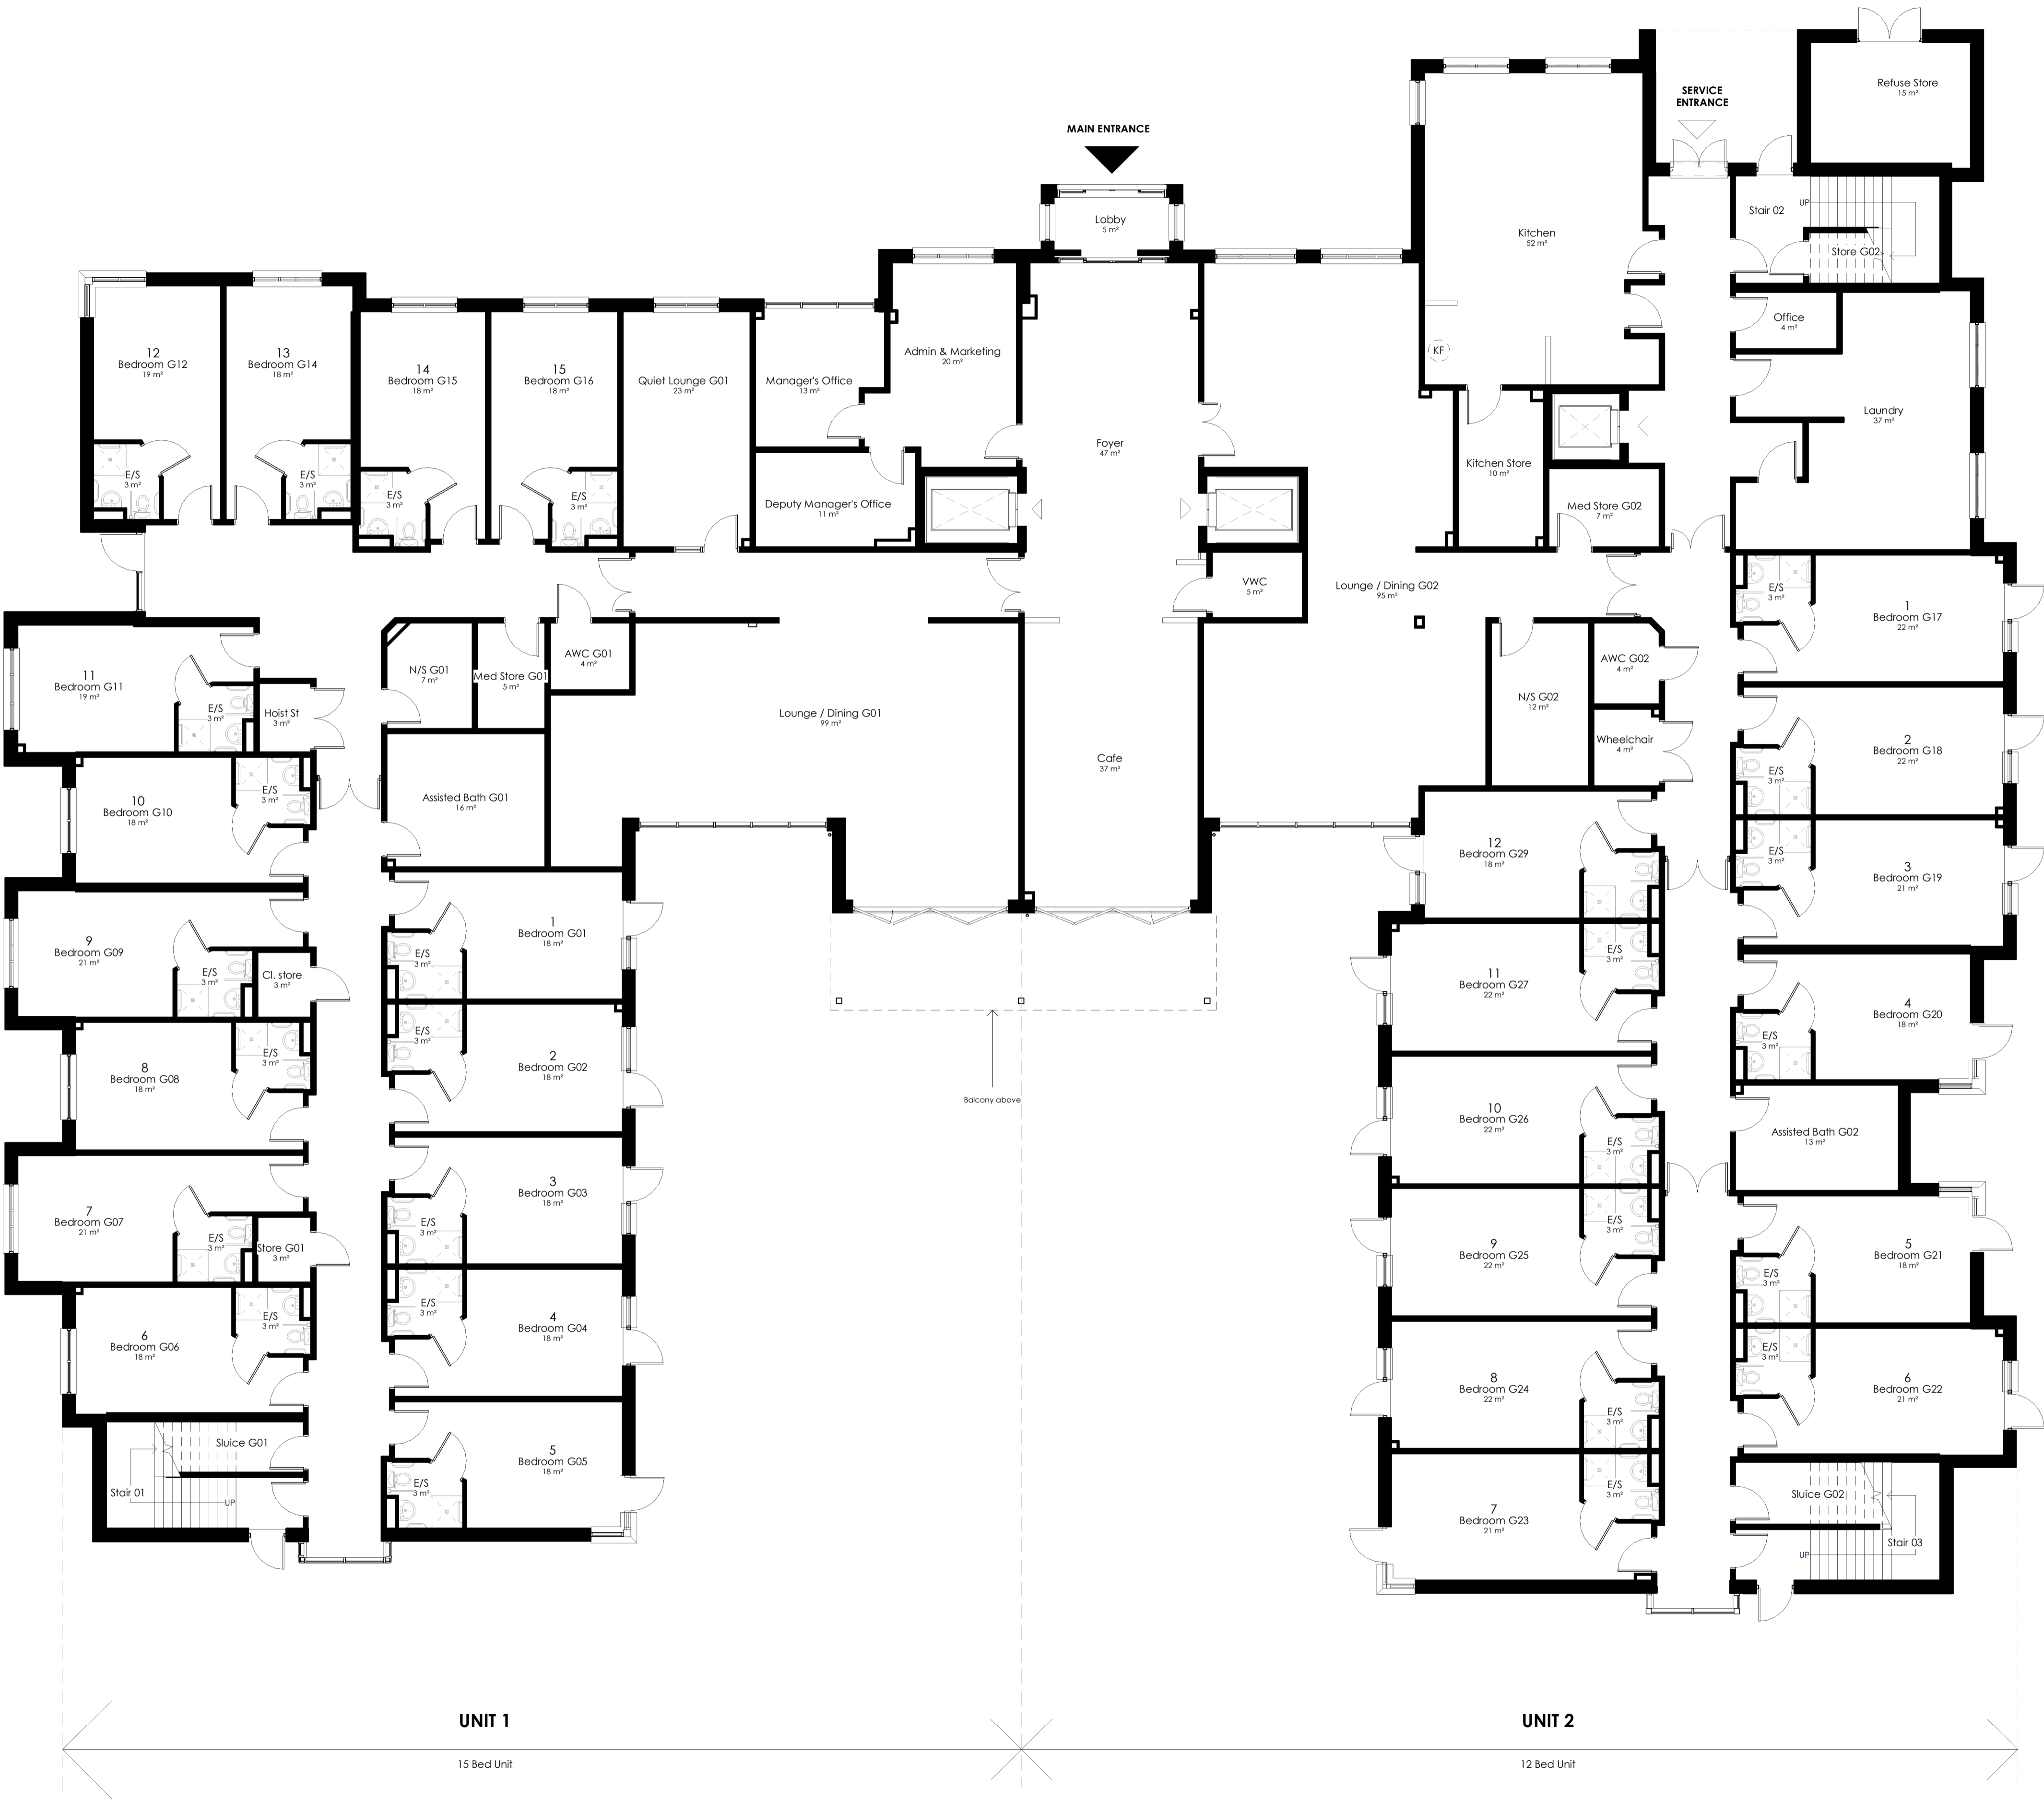
Drawn By
 MP

Drawing No
 17-132-120

Revision
 B

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GROUND FLOOR PLAN - AS PROPOSED
 Scale 1:100 @ A1