


PERMITTED DEVELOPMENT CALCULATION OF VOLUME OF HIP TO GABLE  
 FORMULA FOR HIP TO GABLE = 1/3 (BASE X HEIGHT)  
 VALUE OF BASE - AREA = 1/2 (LENGTH X DEPTH)  
 LENGTH - MEASURE ON SIDE ELEVATION FROM RIDGE OF NEW GABLE TO WHERE IT MEETS THE BOTTOM OF THE ROOF  
 (I.e. WHERE THE ORIGINAL SIDE OF ROOF HAD ITS EAVES)  
 PUT VALUE OF BASE IN FORMULA FOR HIP TO GABLE  
 FORMULA FOR HIP TO GABLE - 1/3. (BASE X HEIGHT)  
 HEIGHT - MEASURE ON EXISTING FRONT ELEVATION DISTANCE FROM THE EXISTING RIDGE (AT TOP OF HIP TO END OF THE RIDGE OF THE PROPOSED GABLE)

VOLUME OF REAR DORMER = 1/2 . (LENGTH X HEIGHT X DEPTH)  
 = 1/2. (6.061 X 2.470 X 1.741)  
 VOLUME OF REAR DORMER = 13.031 CUBIC METERS


VOLUME OF WING DORMER = (LENGTH X DEPTH X HEIGHT-1)  
 = (1.889 X 1.741 X 2.465)  
 = 8.106  
 = (LENGTH X DEPTH X HEIGHT-2) / 2  
 = 3.630 X 1.741 X 2.465 / 2  
 = 7.789  
 = 8.106 + 7.789  
 = 15.895

THEREFORE 13.031 + 15.895= 28.926


**TOTAL VOLUME = 28.926 CUBIC METERS**

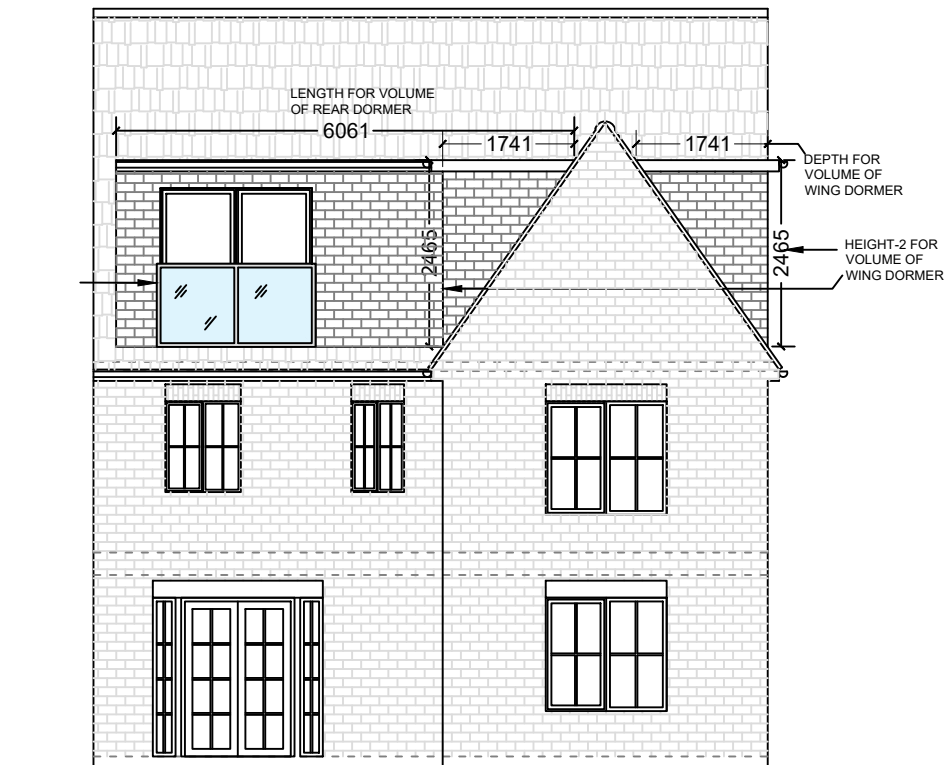

16 PROPOSED REAR ELEVATION  
 SCALE 1:100

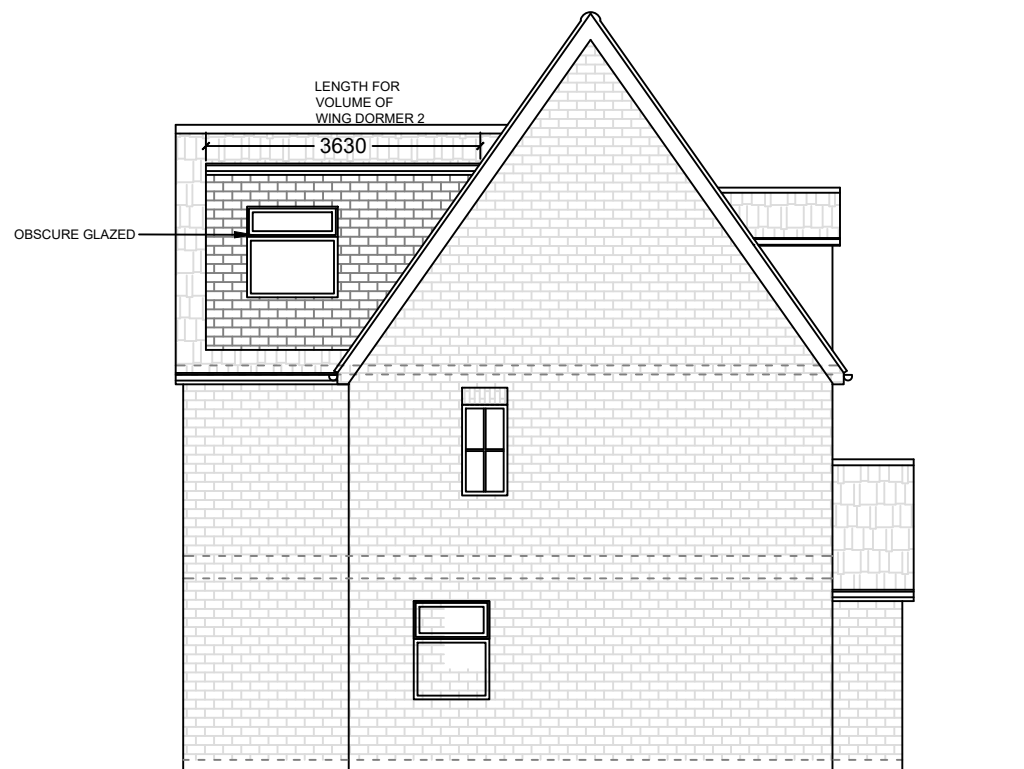

17 PROPOSED L.H SIDE ELEVATION  
 SCALE 1:100

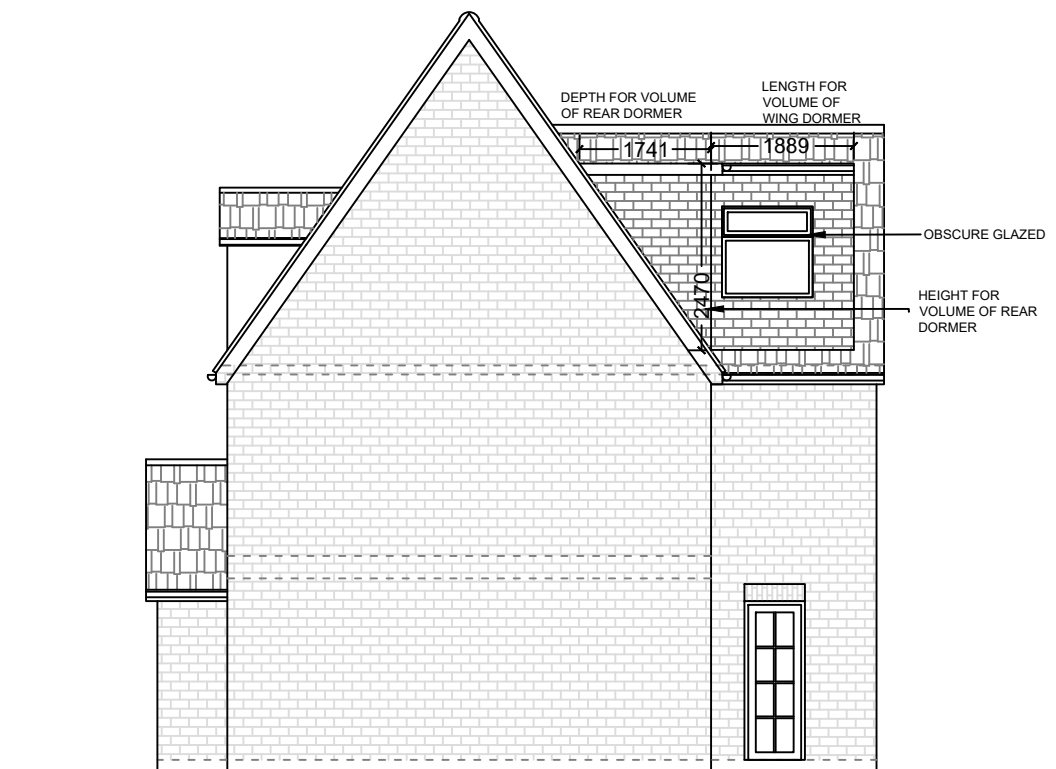

15 PROPOSED R.H SIDE ELEVATION  
 SCALE 1:100

NOTES

PLEASE NOTE:  
 THIS IS NOT A WORKING DRAWING  
 THIS DRAWING IS ONLY FOR PLANNING PURPOSES OR FOR BUILDERS TO OBTAIN ESTIMATES  
 THIS DRAWING IS TO BE READ IN CONJUNCTION WITH ANY OTHER RELEVANT DRAWINGS  
 ALL DETAILS AND DIMENSIONS ARE TO BE CARRIED OUT ON SITE, PRIOR TO WORKS COMMENCING OR ANY ORDERING OF MATERIALS

DRAWING TITLE:  
 CALCULATION

PROJECT LOCATION:  
 16 Nimrod Dr, Hatfield AL10 9LS, UK

DATE:  
 APRIL 2022

DRAWING NO:  
 16NDHA 11 A



SCALE:  
 1:100 @ A3

