

PROPOSED FRONT ELEVATION

SCALE 1:100 @ A1

PROPOSED SIDE ELEVATION


SCALE 1:100 @ A1

PROPOSED REAR ELEVATION

SCALE 1:100 @ A1


PROPOSED SIDE ELEVATION

SCALE 1:100 @ A1

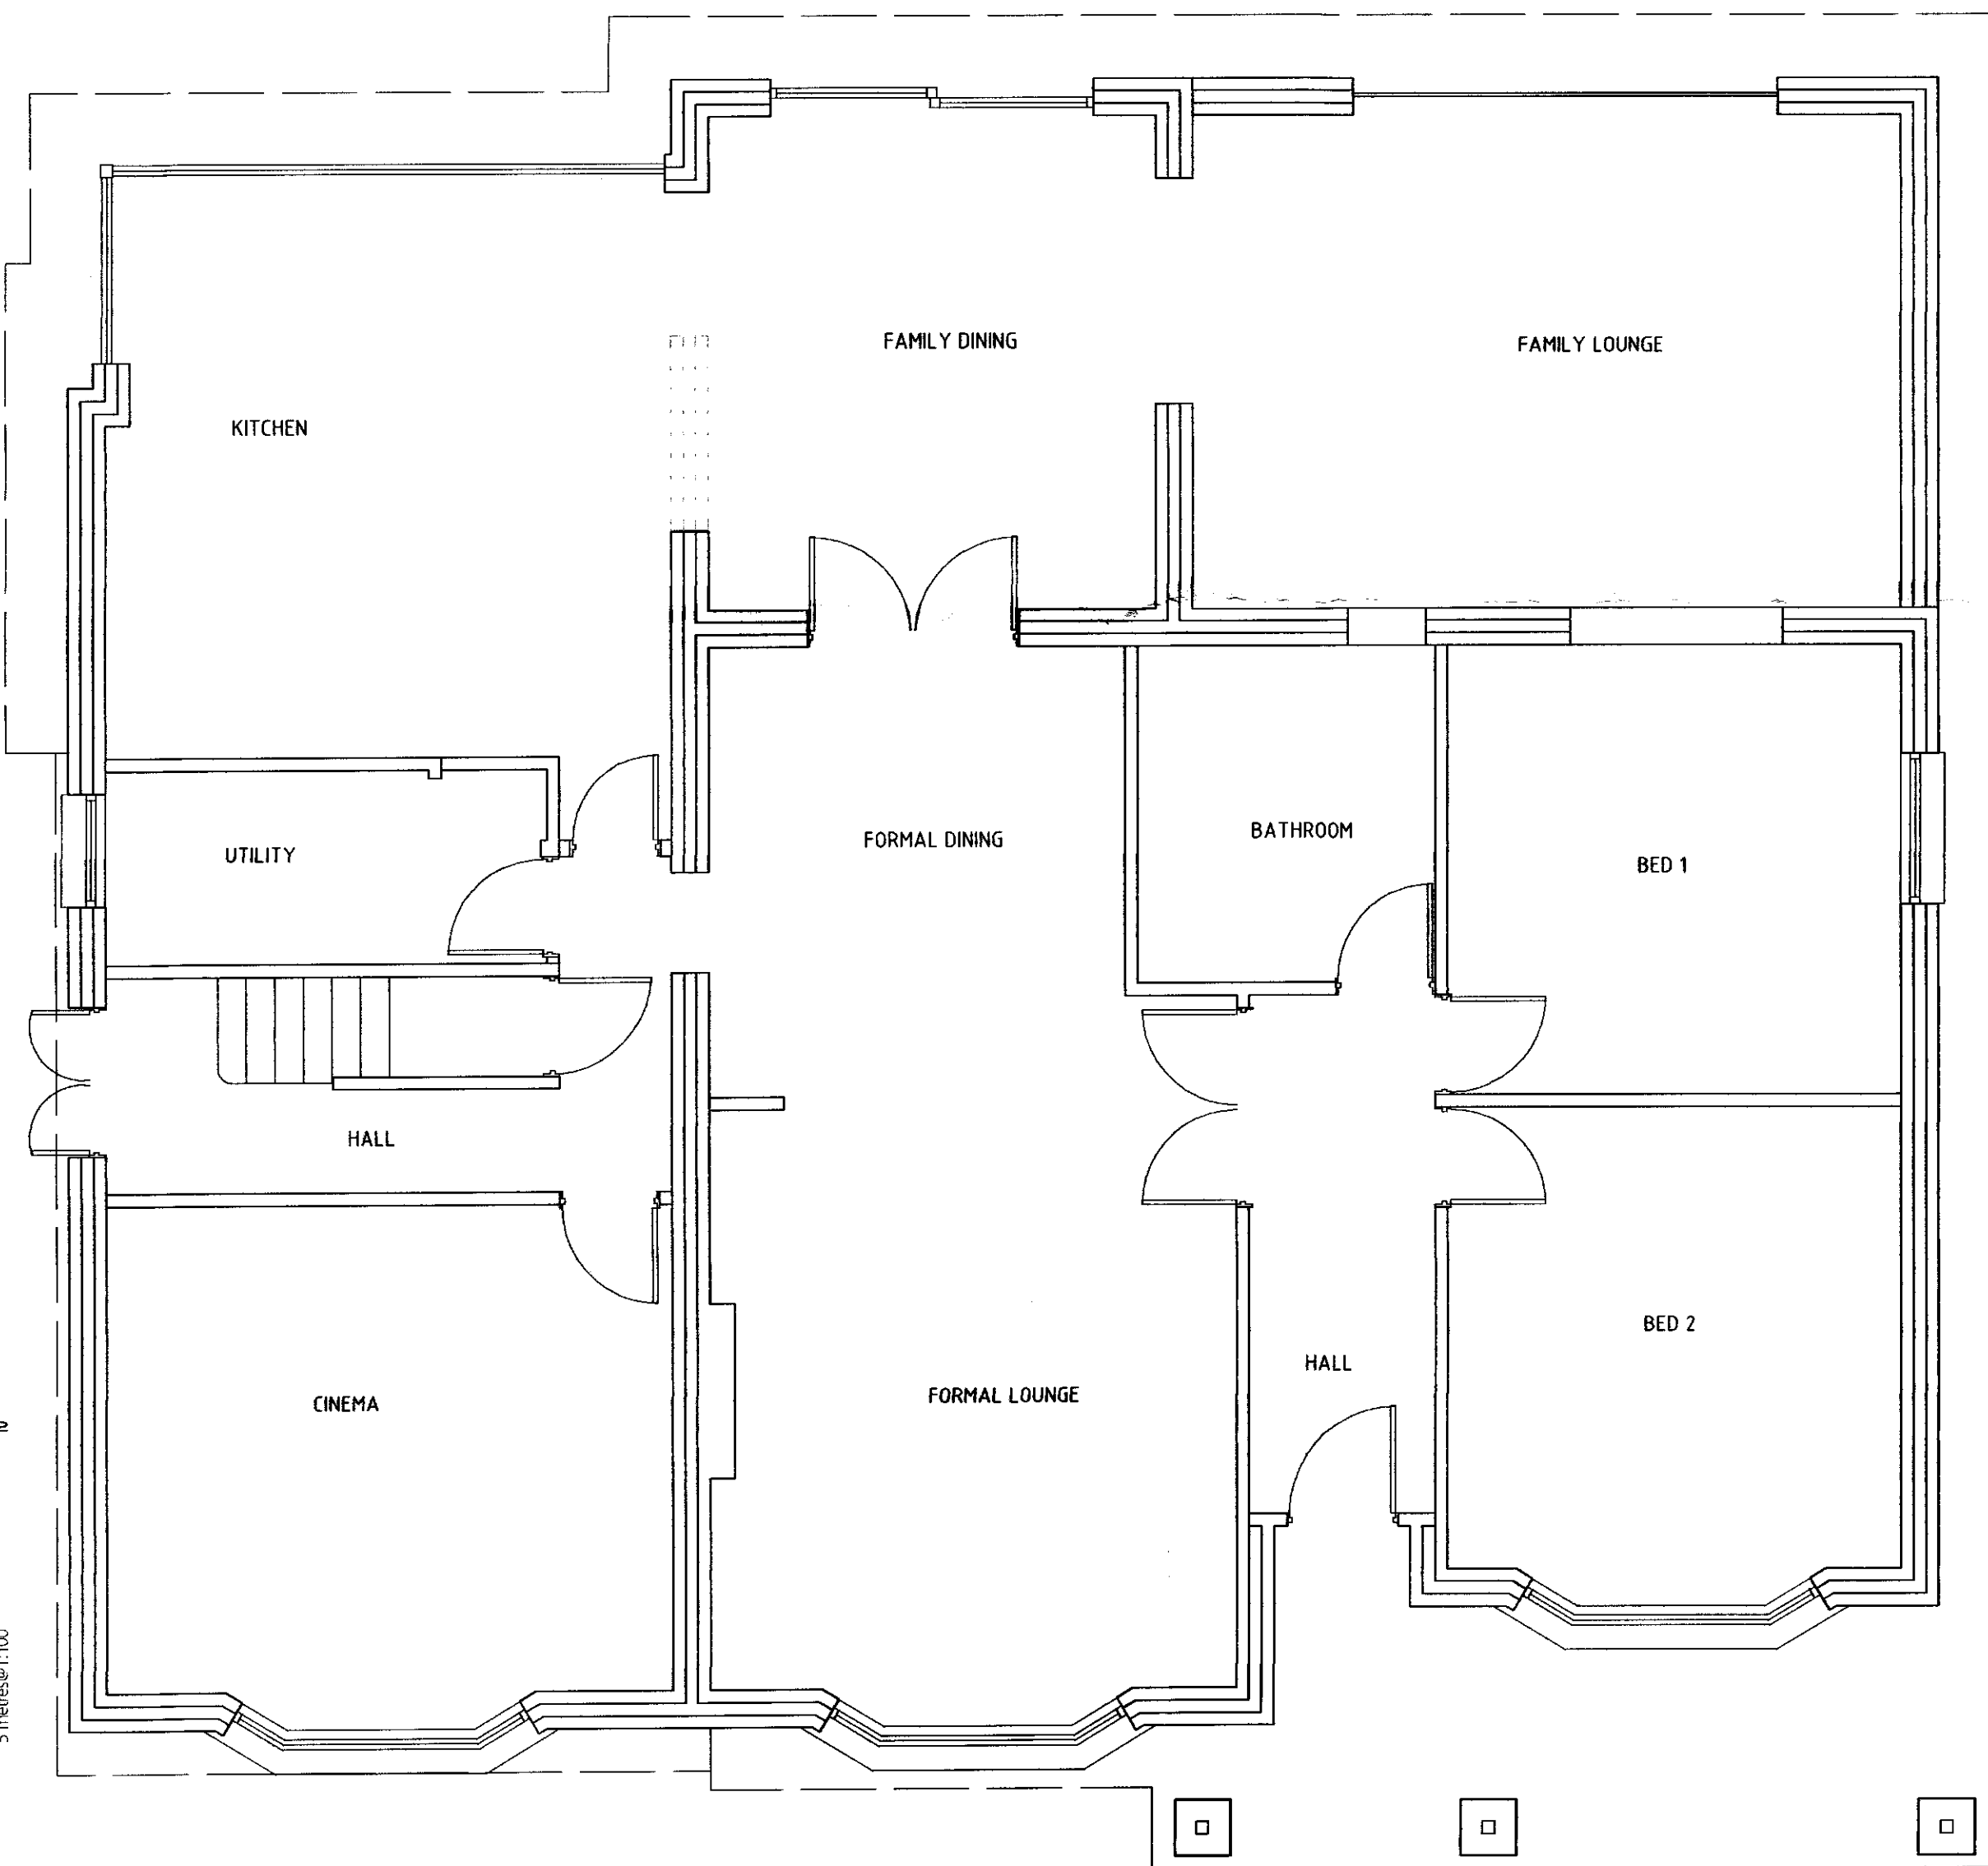

PROPOSED GROUND FLOOR PLAN

SCALE 1:100 @ A1

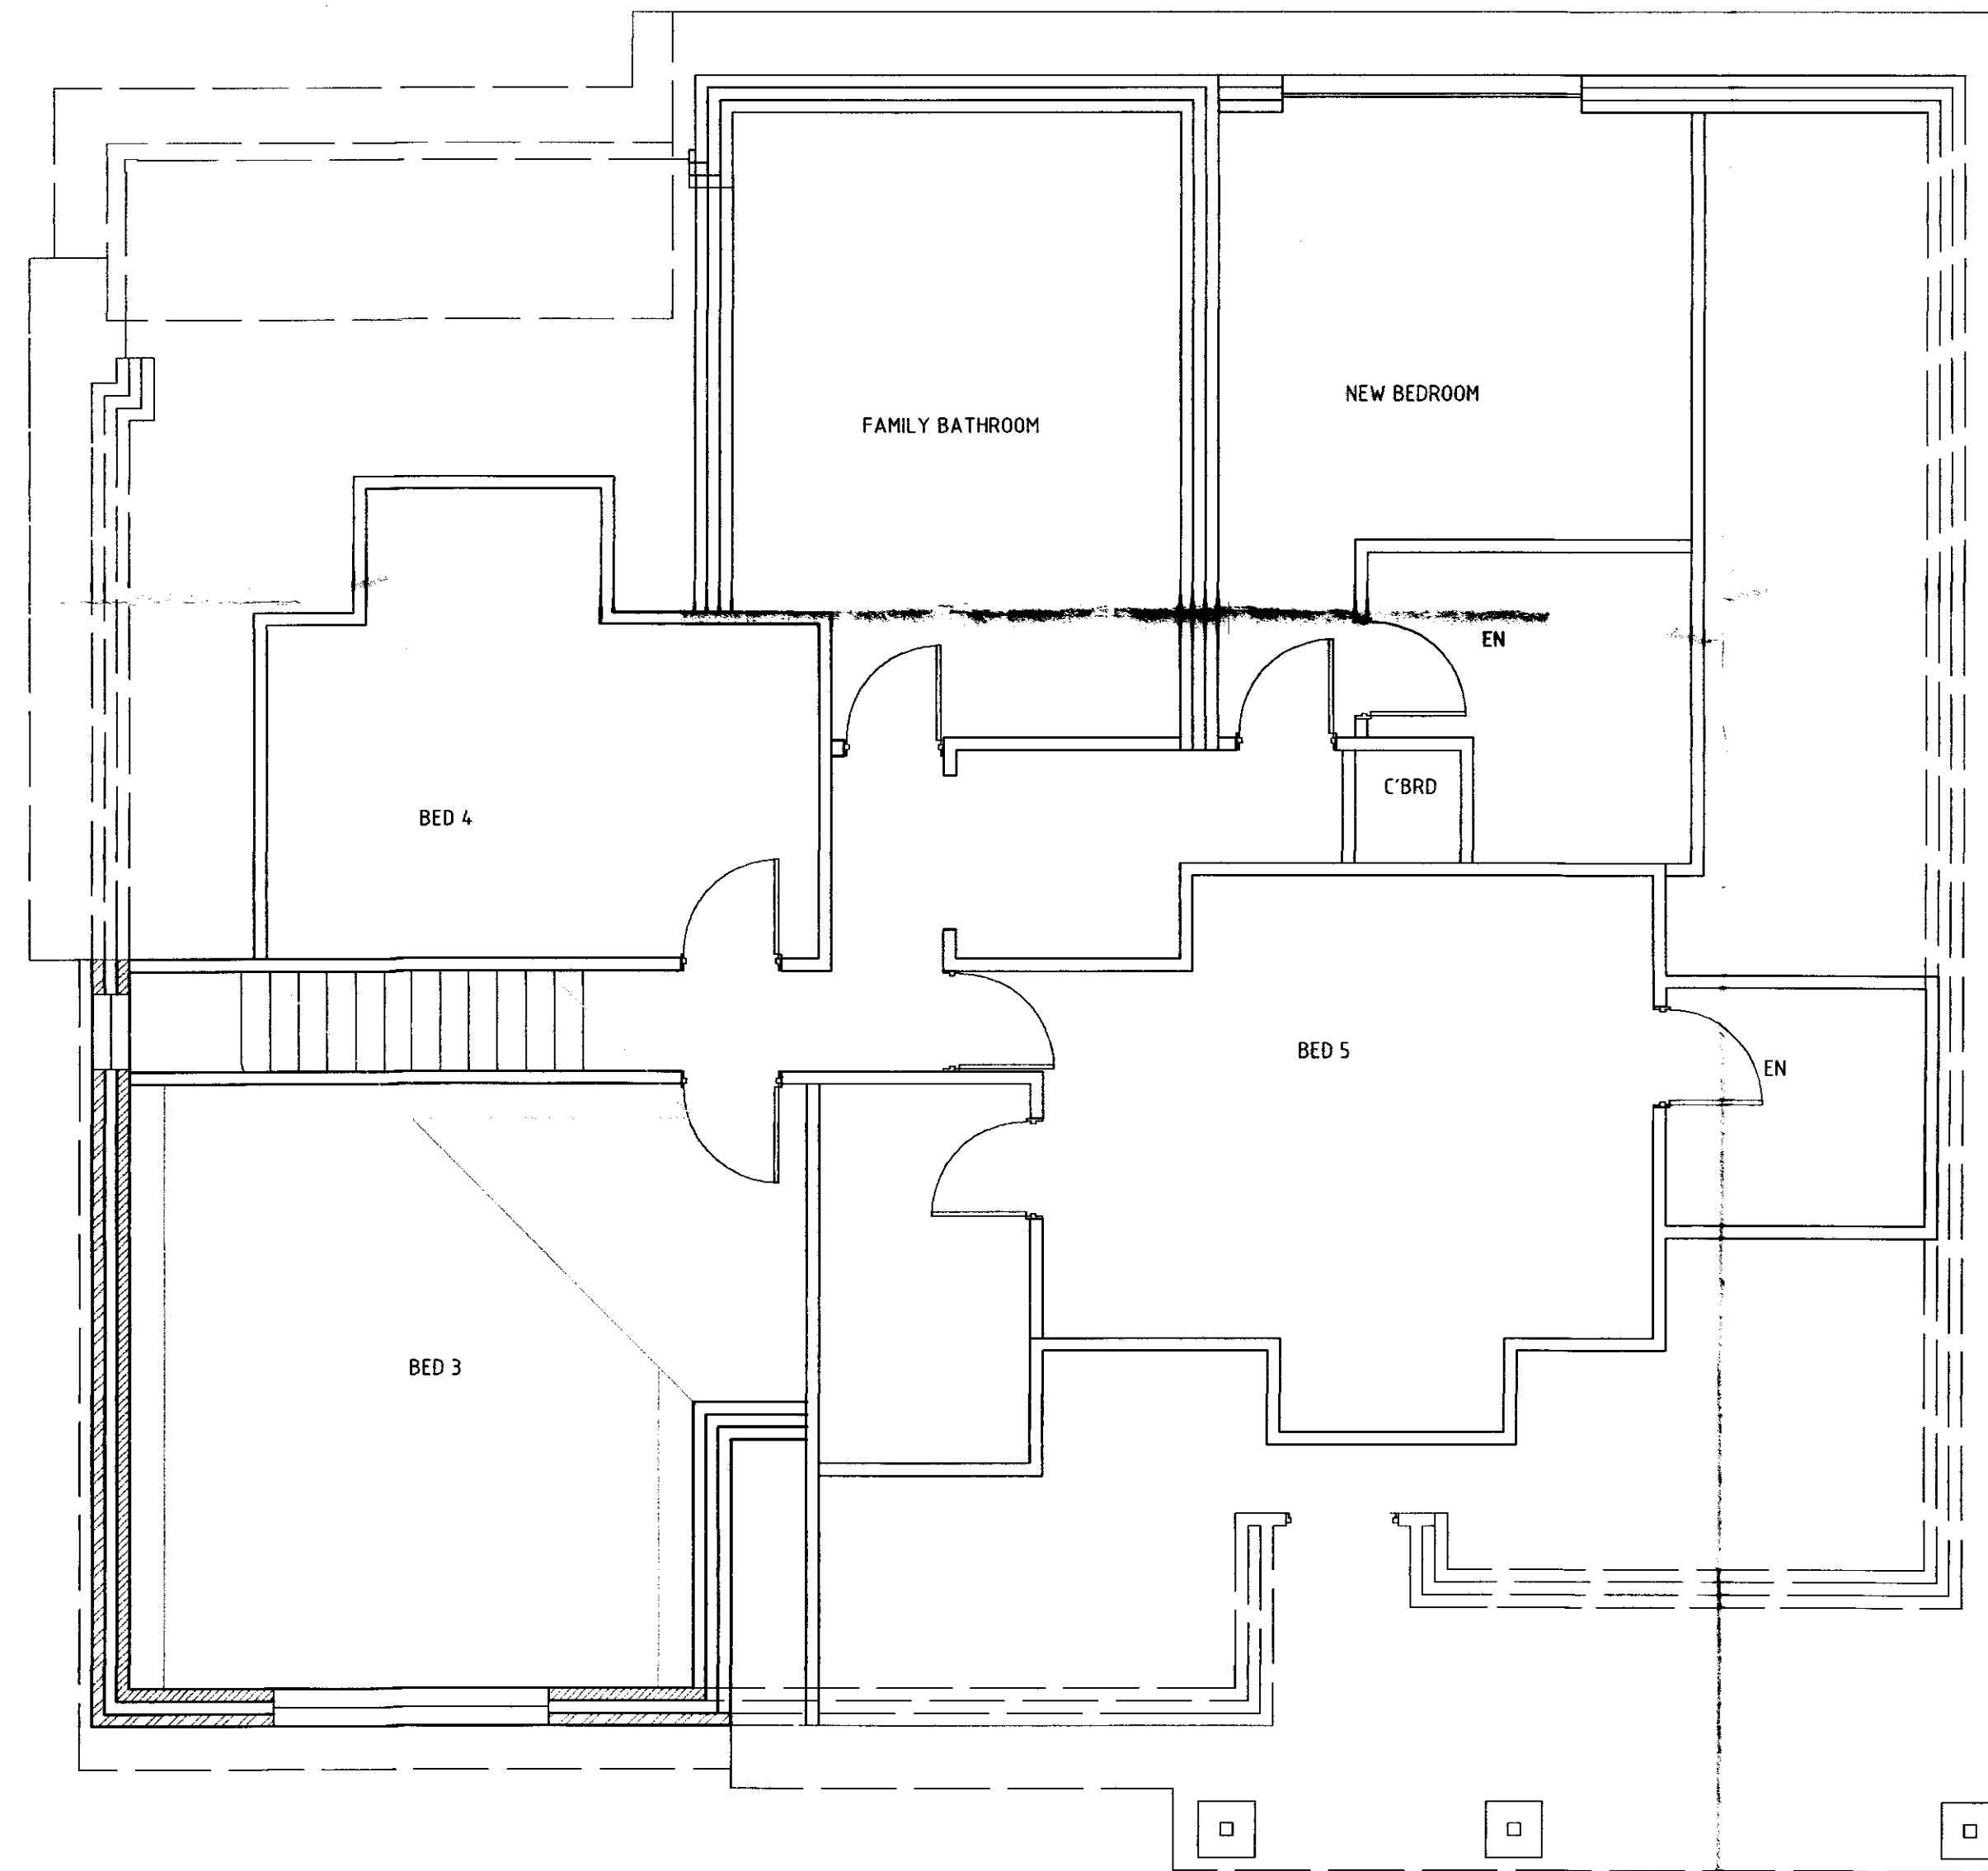

PROPOSED FIRST FLOOR PLAN

SCALE 1:100 @ A1

NOTES

GENERAL

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All dimensions are in millimeters. Unless noted otherwise.

If in doubt - ASK!

This drawing is not to be used for setting out.

All sizes and dimensions to be checked on site prior to commencement and confirmed by the Architect. This drawing is to be read in conjunction with all other relevant drawings and details.

All timber to be preservative treated against fungal and insect attack. Softwood graded as indicated in the specification or plans to C16 (European redwood / whitewood to BS 4978 GS grade) or C24 (ditto SS grade) of BS EN 338 according to BS 5268-Part 2. Average moisture content at time of grading and delivery to be 18% with no piece greater than 24%. Finger jointed members are not permitted (other than in proprietary manufactured glulam members) unless specifically approved by the engineer. Unless otherwise noted all timber sizes specified are the desired final target size to tolerance class T1 (sawn). Where T2 (machined / regularised) tolerances are required they will be so indicated.

Materials and workmanship must be of a standard conforming with the appropriate recognised authority. For example "National House Building Council", "British Standards Institution", "Department of the Environment - (Building Regulations 1991)" etc.

HEALTH & SAFETY

The Contractor must at all times operate safe working practices, maintain the integrity of the existing structures, and conform to all the appropriate requirements of the Health & Safety Executive including the "Construction (Health, Safety and Welfare) Regulations 1996".

The working methods of any hazardous operations must first be discussed with the designer and or project manager prior to commencement

NOT FOR CONSTRUCTION

| Rev. | Amendments | Date |
|------|------------|---------------|
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| | | - 1 FEB 2012 |
| | | No. 2012/0193 |

Client:
MR & MRS R. LETO
10 WILKINS GREEN LANE
SMALLFORD, HATFIELD, AL10 9RT

Project:
FIRST FLOOR FRONT GABEL EXTENSION
AND OPEN PORCH
10 WILKINS GREEN LANE
SMALLFORD, AL10 9RT

Drawing title:
GENERAL ARRANGEMENTS
PLANS & ELEVATIONS AS PROPOSED

Derek LOFTY & Associates

The Lodge Studio | Copthorne Road | Croxley Green
 Hertfordshire | WD3 4AD
 T: 01923 774373 | F: 01923 896299
 e: info@dlaconsultants.co.uk

| DATE | SCALE | DRAWING No. | DRAWN | Rev. |
|---------|-------|-------------|-------|------|
| Jan -12 | SHOWN | 4940-202 | AML | - |

Original size A1
3 metres @ 1:50
5 metres @ 1:100