



EXISTING FRONT ELEVATION

PROPOSED FRONT ELEVATION

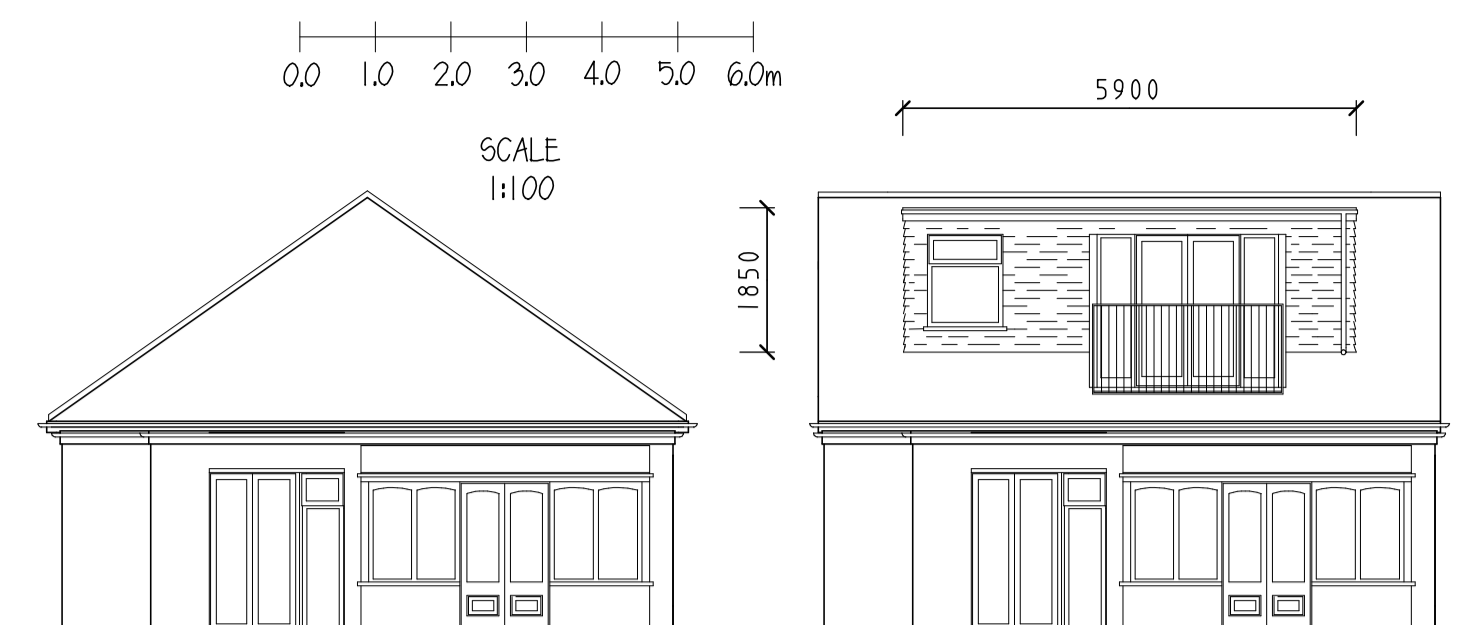

EXISTING REAR ELEVATION

PROPOSED REAR ELEVATION

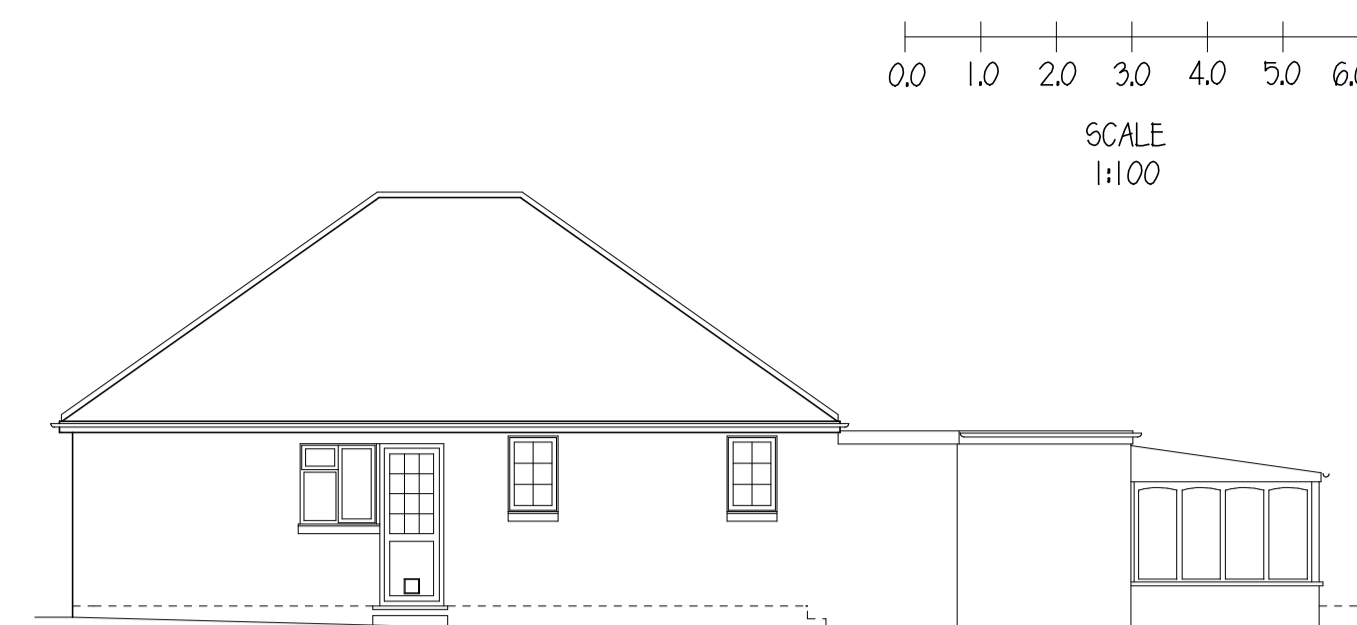

EXISTING SIDE ELEVATION (SOUTH)

PROPOSED SIDE ELEVATION (SOUTH)

NB. WINDOWS ON FLANK GABLE WALLS TO BE OF OBSCURED GLASS. SAME WINDOW TO BE NON-OPENABLE IF LESS THAN 1.7M ABOVE THE FLOOR OF THE ROOM IN WHICH THE WINDOW IS INSTALLED

NB. PROPOSED ROOFLIGHTS NOT TO PROTRUDE MORE THAN 150MM FROM THE PLANE OF THE SLOPE OF THE ORIGINAL ROOF


NB. ALL MATERIALS TO MATCH EXISTING

SCALE 1:50

SCALE 1:100


EXISTING SIDE ELEVATION (NORTH)

PROPOSED SIDE ELEVATION (NORTH)

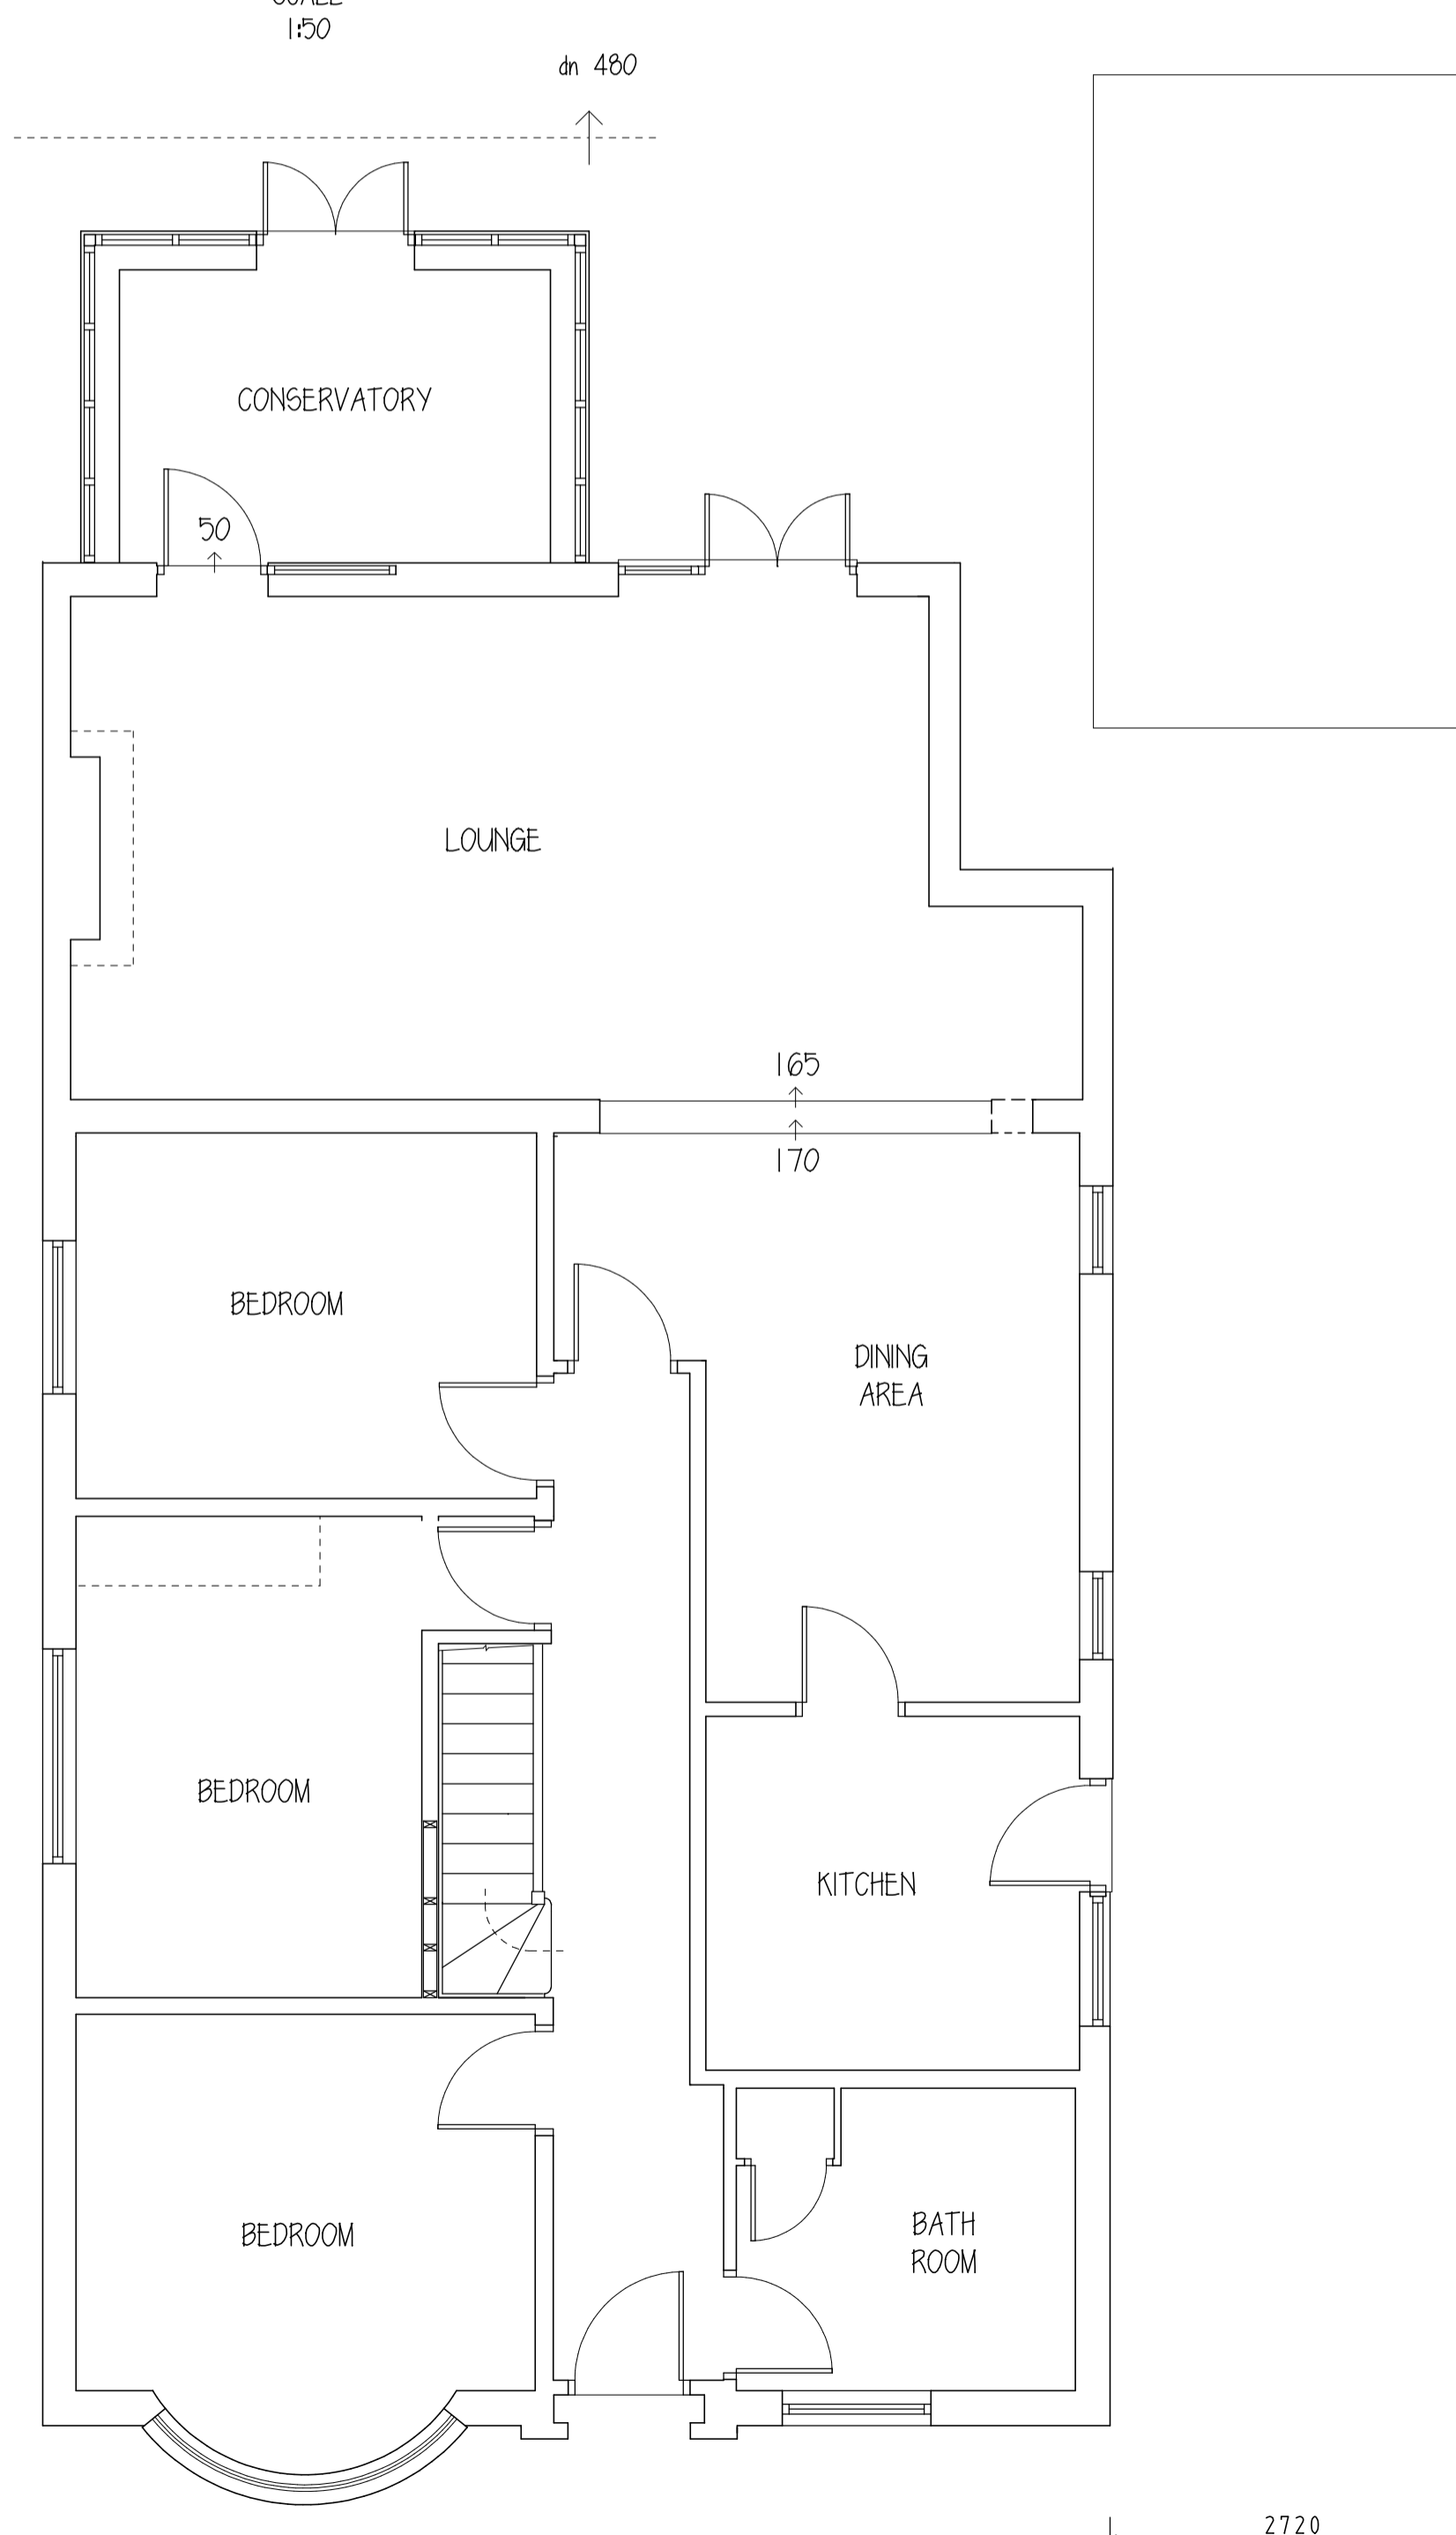


PROPOSED GROUND FLOOR LAYOUT

SCALE 1:50

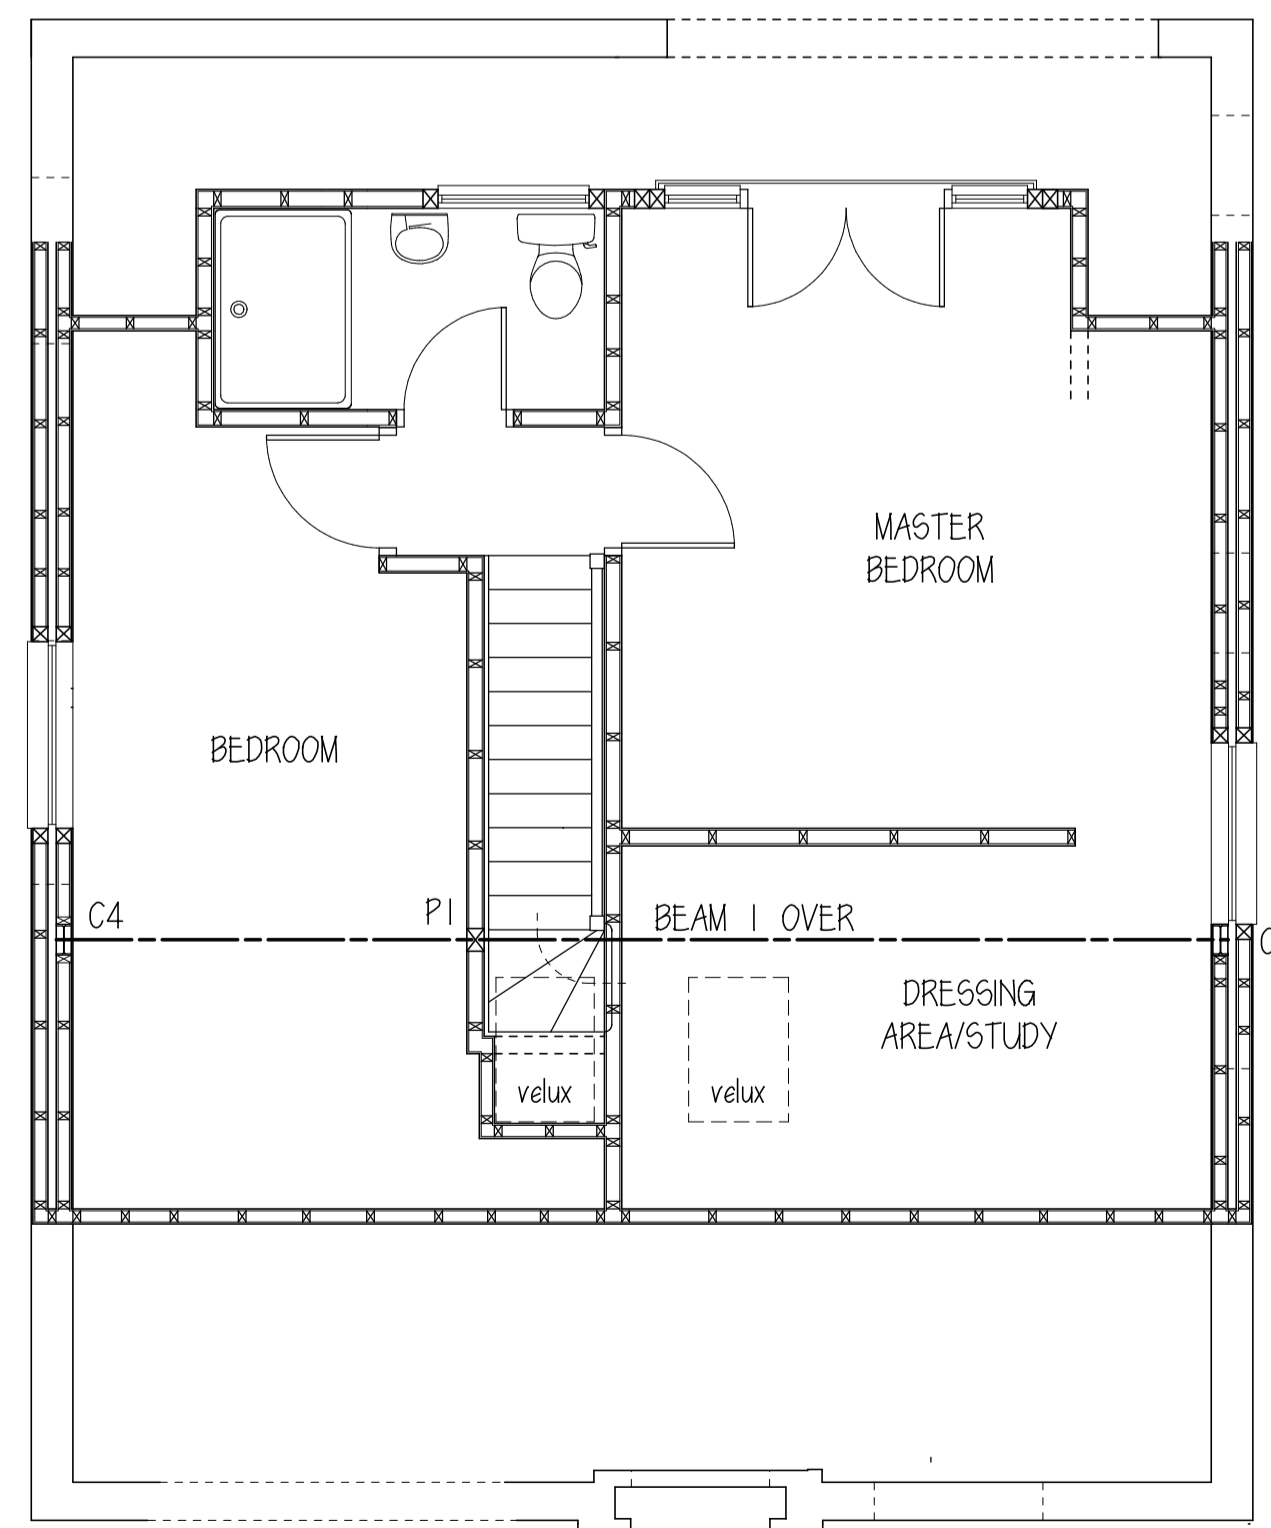

PROPOSED LOFT FLOOR LAYOUT

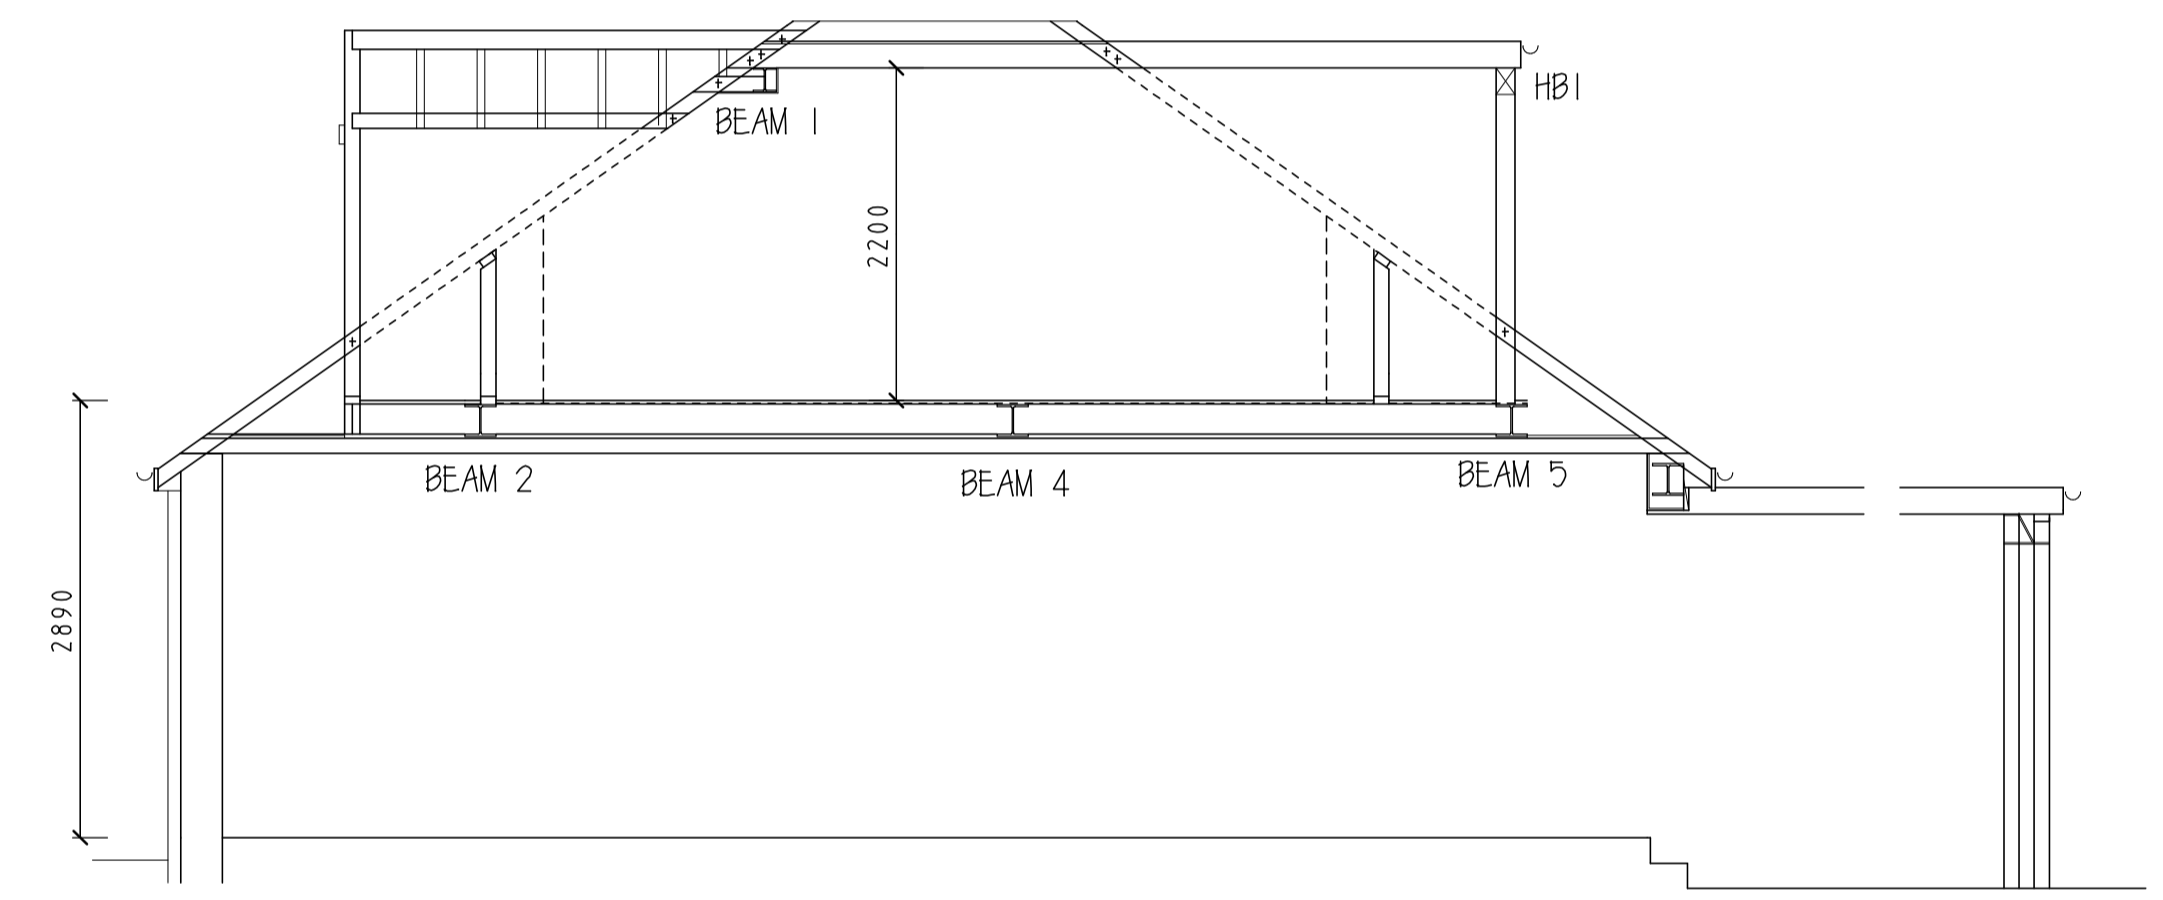

PROPOSED SECTION

SCALE 1:50

SPECIFICATION/NOTES

1. COPYRIGHT: Written consent must be obtained from Carter Surveying Associates for reproducing or copying this drawing in part or in whole.
2. PARTY WALL etc. ACT 1996: This work may be affected by the provisions of the Party Wall etc. Act 1996.
3. All work is to be carried out in compliance with the current bye-laws and regulations of the local authority.
4. All dimensions are to be checked on site by the contractor and works set out accordingly.
5. All works are to comply with the relevant British Standards and Code of Practice Specifications.

Amendments:	
CARTER SURVEYING ASSOCIATES 07941 443968	
SITE ADDRESS:	CLIENT:
13 THEOBALDS ROAD CUFFLEY, HERTS. EN6 4HQ	MR K BURGESS
PROJECT:	DRAWING:
LOFT CONVERSION	PLANNING
SCALES: 1:50 1:100 @ A1	DATE: FEB 2018
DRAWING NO: BUR 01P	DRAWN: CSA
REVISION:	A