




PROPOSED SECTION A-A  
SCALE 1:50

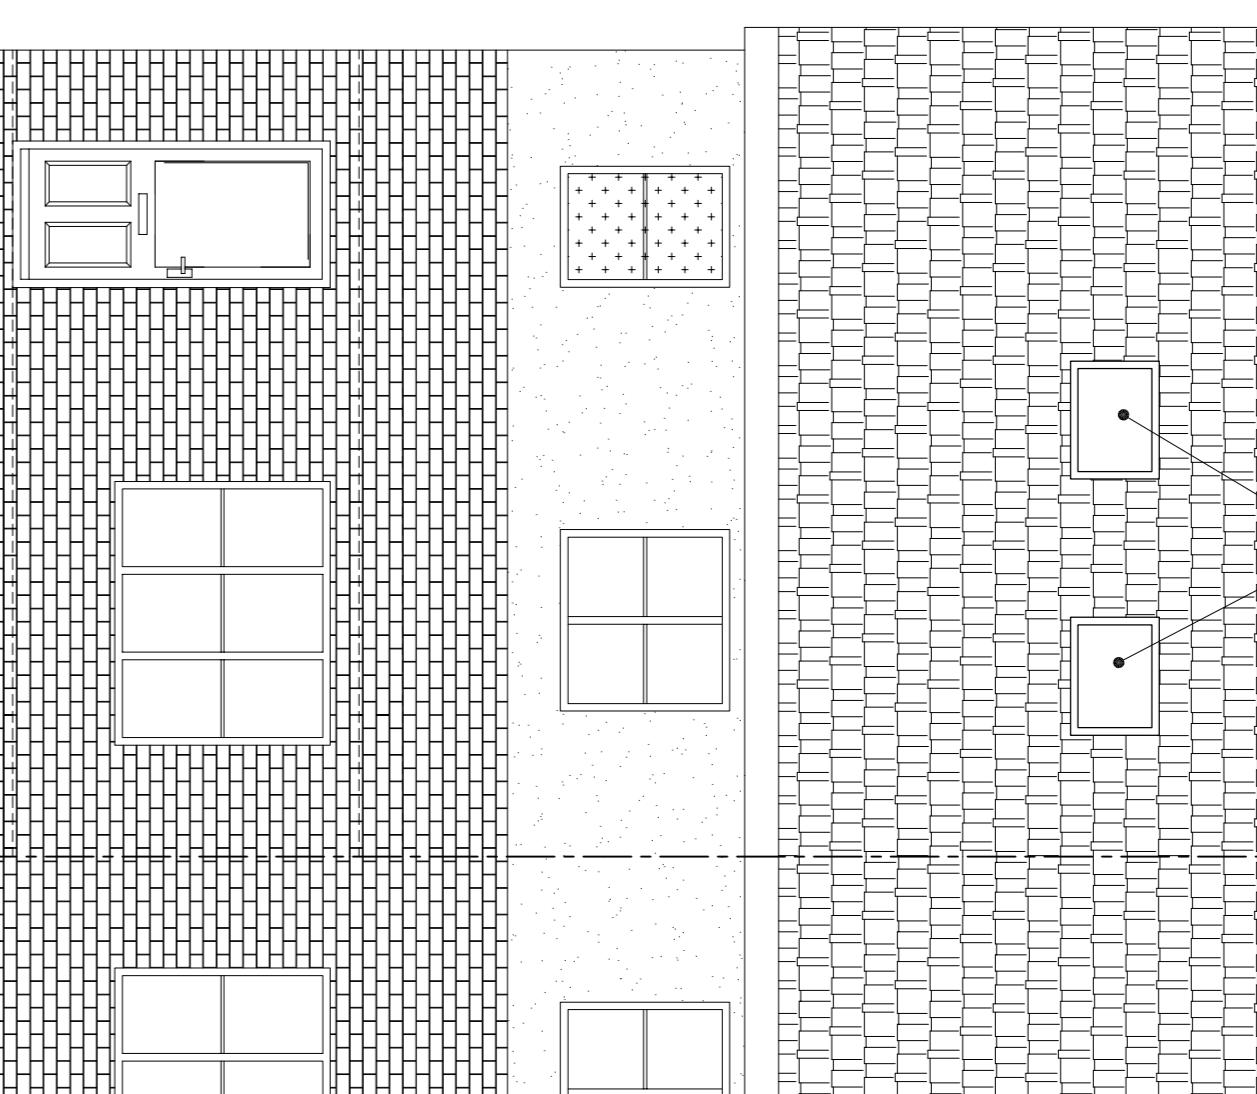


PROPOSED SIDE ELEVATION "A"  
SCALE 1:50

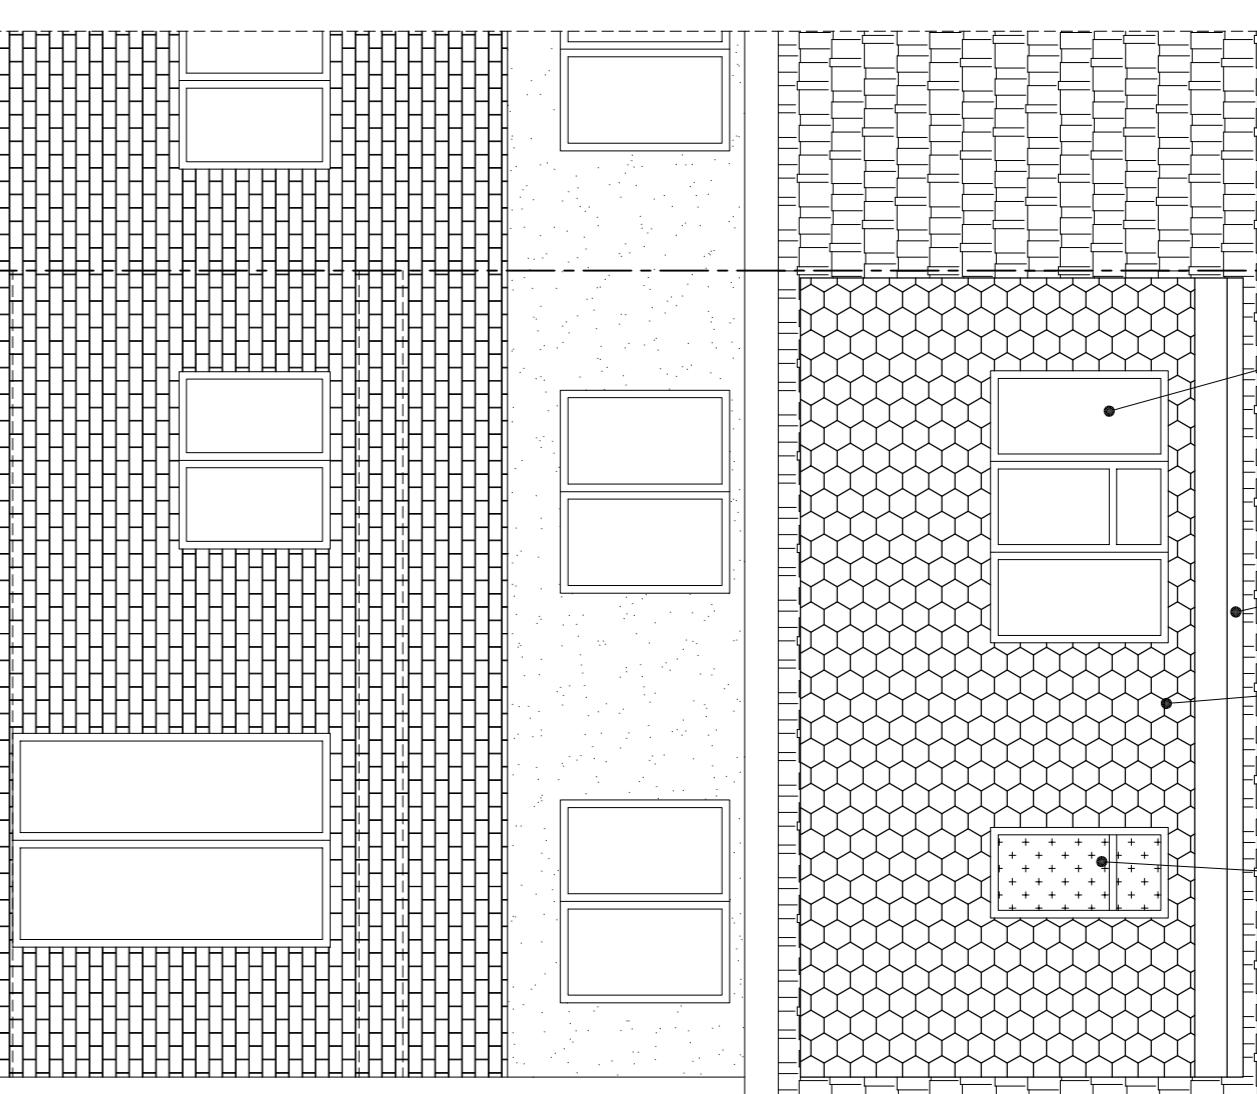

PROPOSED SIDE ELEVATION "B"  
SCALE 1:50

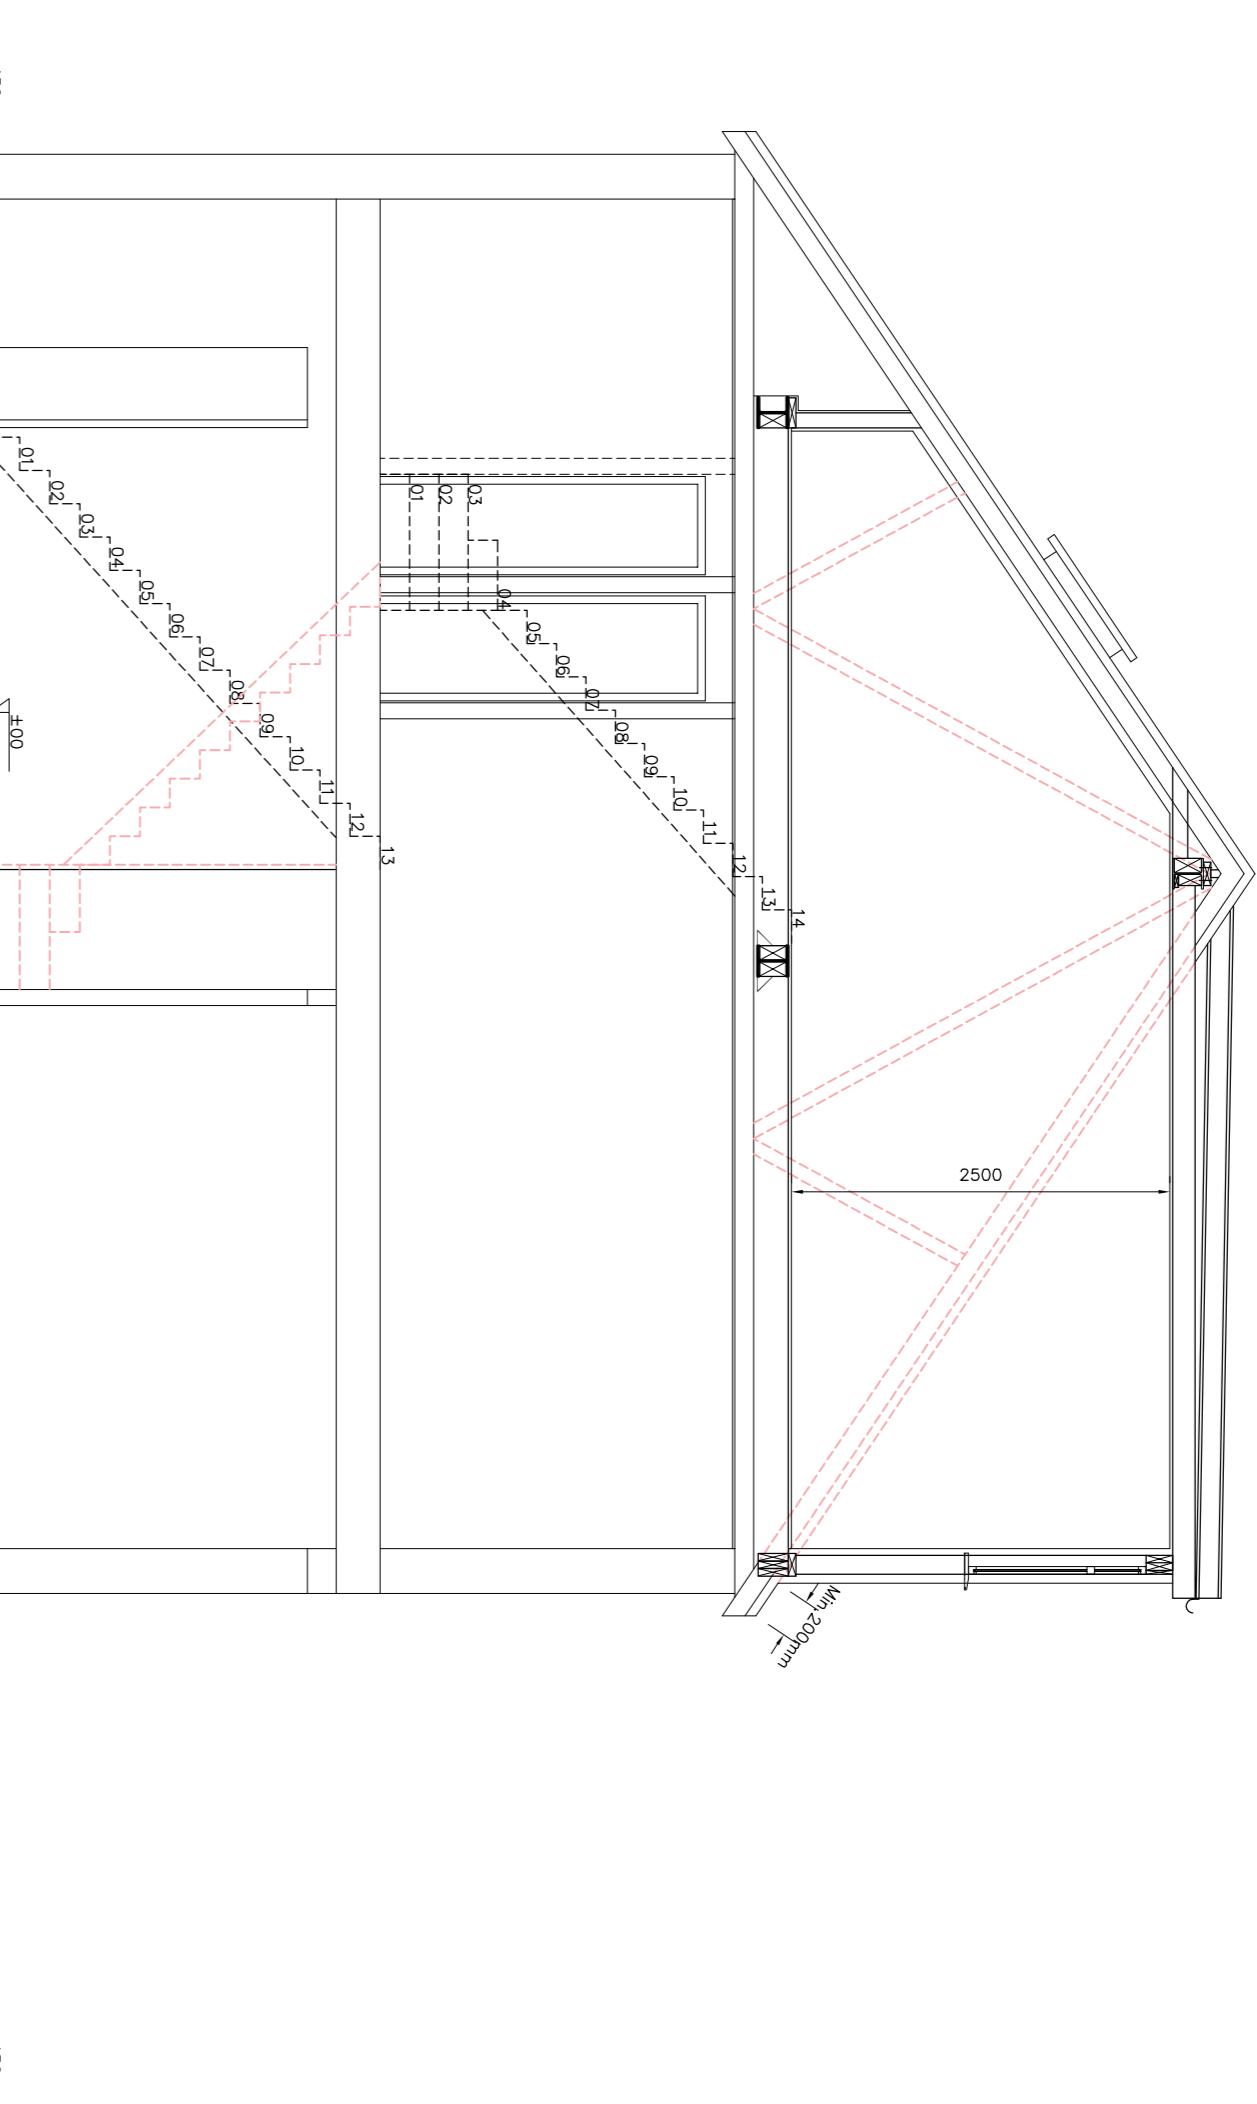

PROPOSED FRONT ELEVATION  
SCALE 1:50

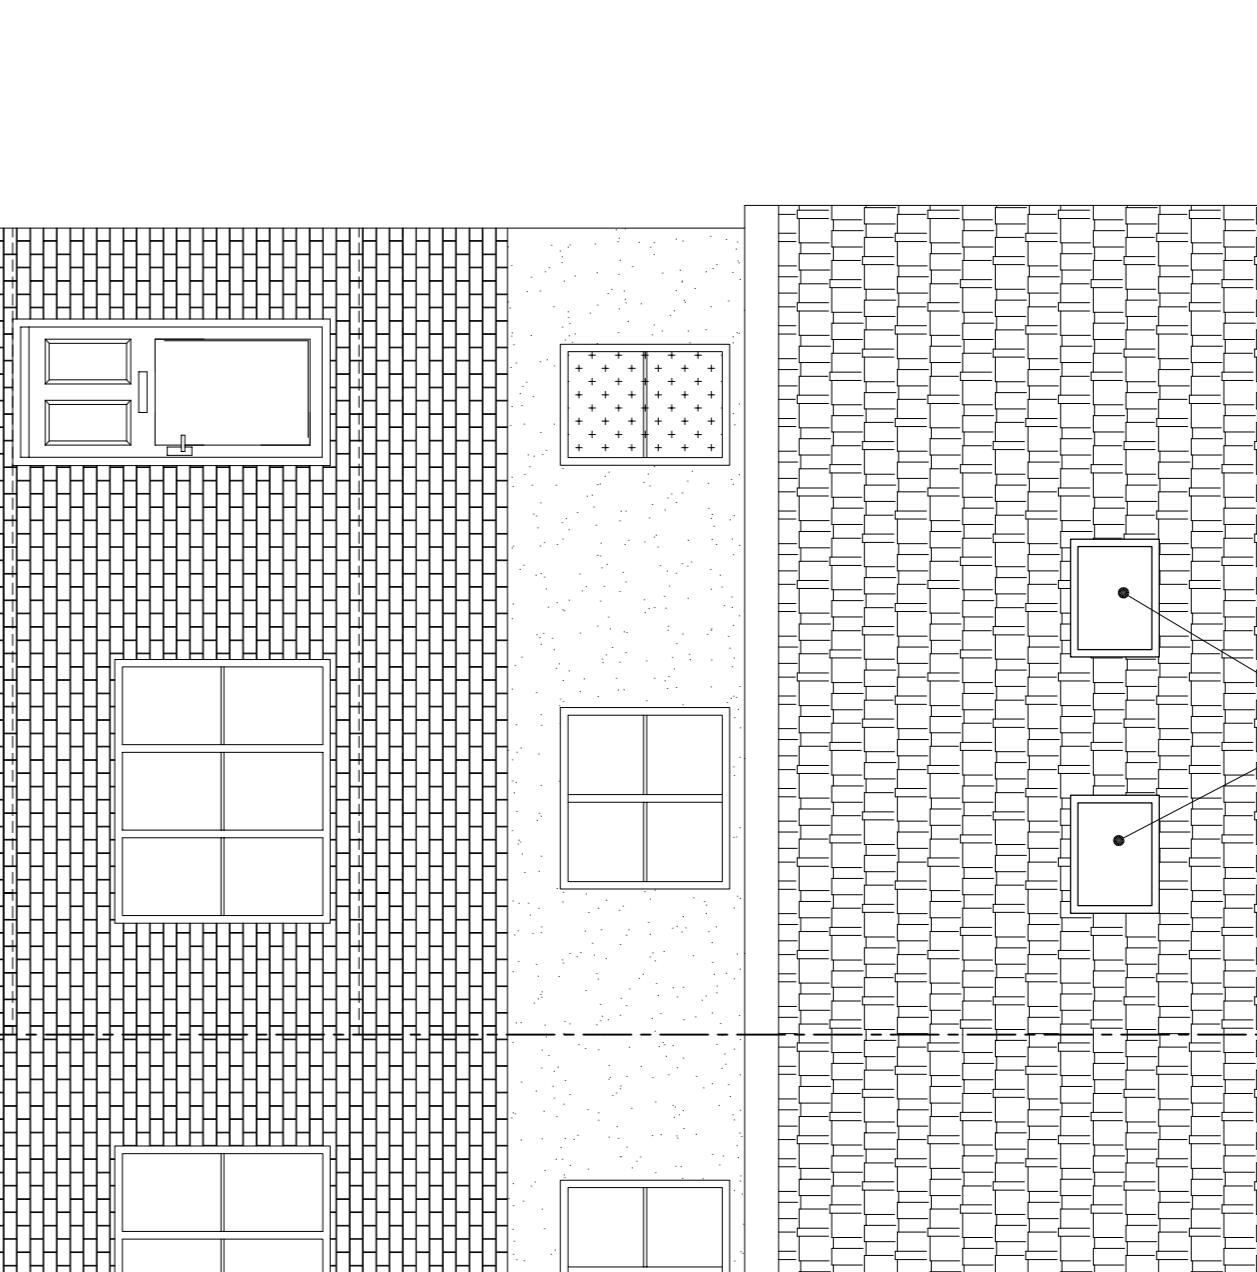


PROPOSED REAR ELEVATION  
SCALE 1:50

VOLUME CALCULATION

Dormer volume  $V = A \times L$

$$= 6.5 \times 2.284 \\ = 34.87m^3 < 40.0m^3 (OK)$$

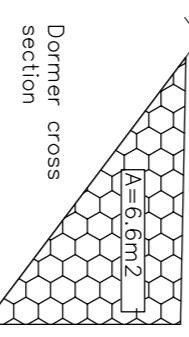

Dormer cross  
section

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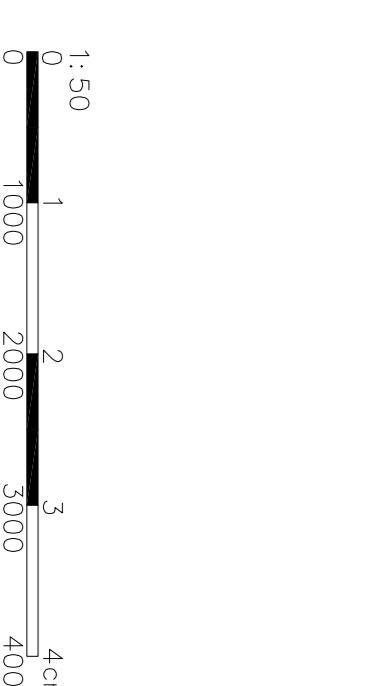
Drawing Title:

PROPOSED SECTION AND

PROPOSED ELEVATIONS

Drawn SS AUG 2022  
Checked Rev.

Date: 02/08/2022  
Drawing No.: PL-03  
Project No.: KKR-1465  
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Drawing Title:	PROPOSED SECTION AND
PROPOSED ELEVATIONS	
Drawn	SS AUG 2022
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