
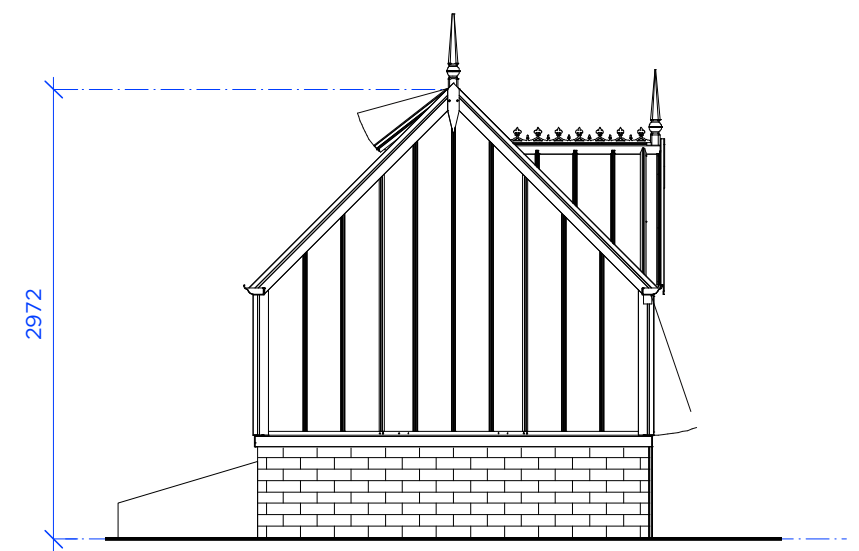


- NOTES**
1. This drawing has been based upon OUTLINE measurements, NOT a full measured survey. As a result, considerable attention to the dimensions of any proposed works must be applied, taking site dimensions and templates as necessary.
  2. While this drawing can be used as a base drawing for construction purposes, it is VERY IMPORTANT that all dimensions are checked carefully before any work commences or any materials are ordered.
  3. This drawing can be used as part of a planning application, although your planning officer may ask for more specific information about some aspects of the design. For further information ask your architect.
  4. Where applicable, a suitable Structural Engineer and/or a Party Wall Surveyor should be consulted. Although as far as possible these instances have been indicated, this is not necessarily exhaustive and the whole scope of proposed works should be reviewed.
  5. This is a 'Scheme Level Drawing' and is intended to illustrate the general arrangement and potential of the project proposal. As it stands this drawing does not include all of the detail necessary for a full plans building regulations application.
  6. Before proceeding with any works it is important to discuss, with your architect, project manager and builder together, where more detail would be appropriate.

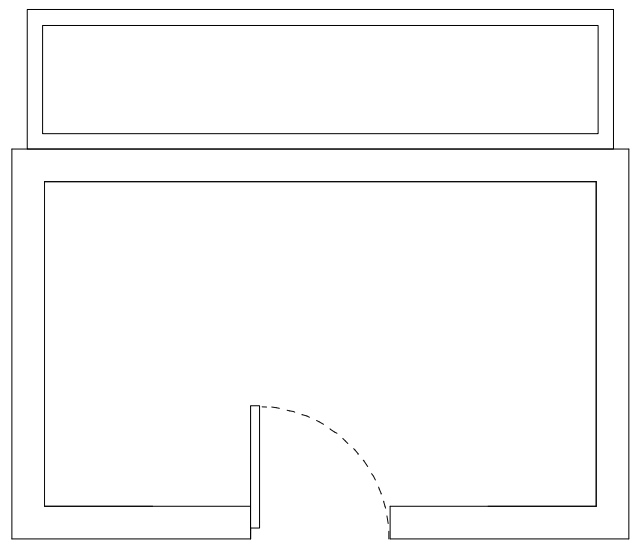


**Alitex National Trust Greenhouse**  
Aluminium glass frame with brick low-level brick base.  
Door colour to match windows and doors of existing house.

1 Greenhouse Proposed Plan  
Scale: 1:50

2 Greenhouse Side Elevation  
Scale: 1:50

3 Greenhouse Front Elevation  
Scale: 1:50

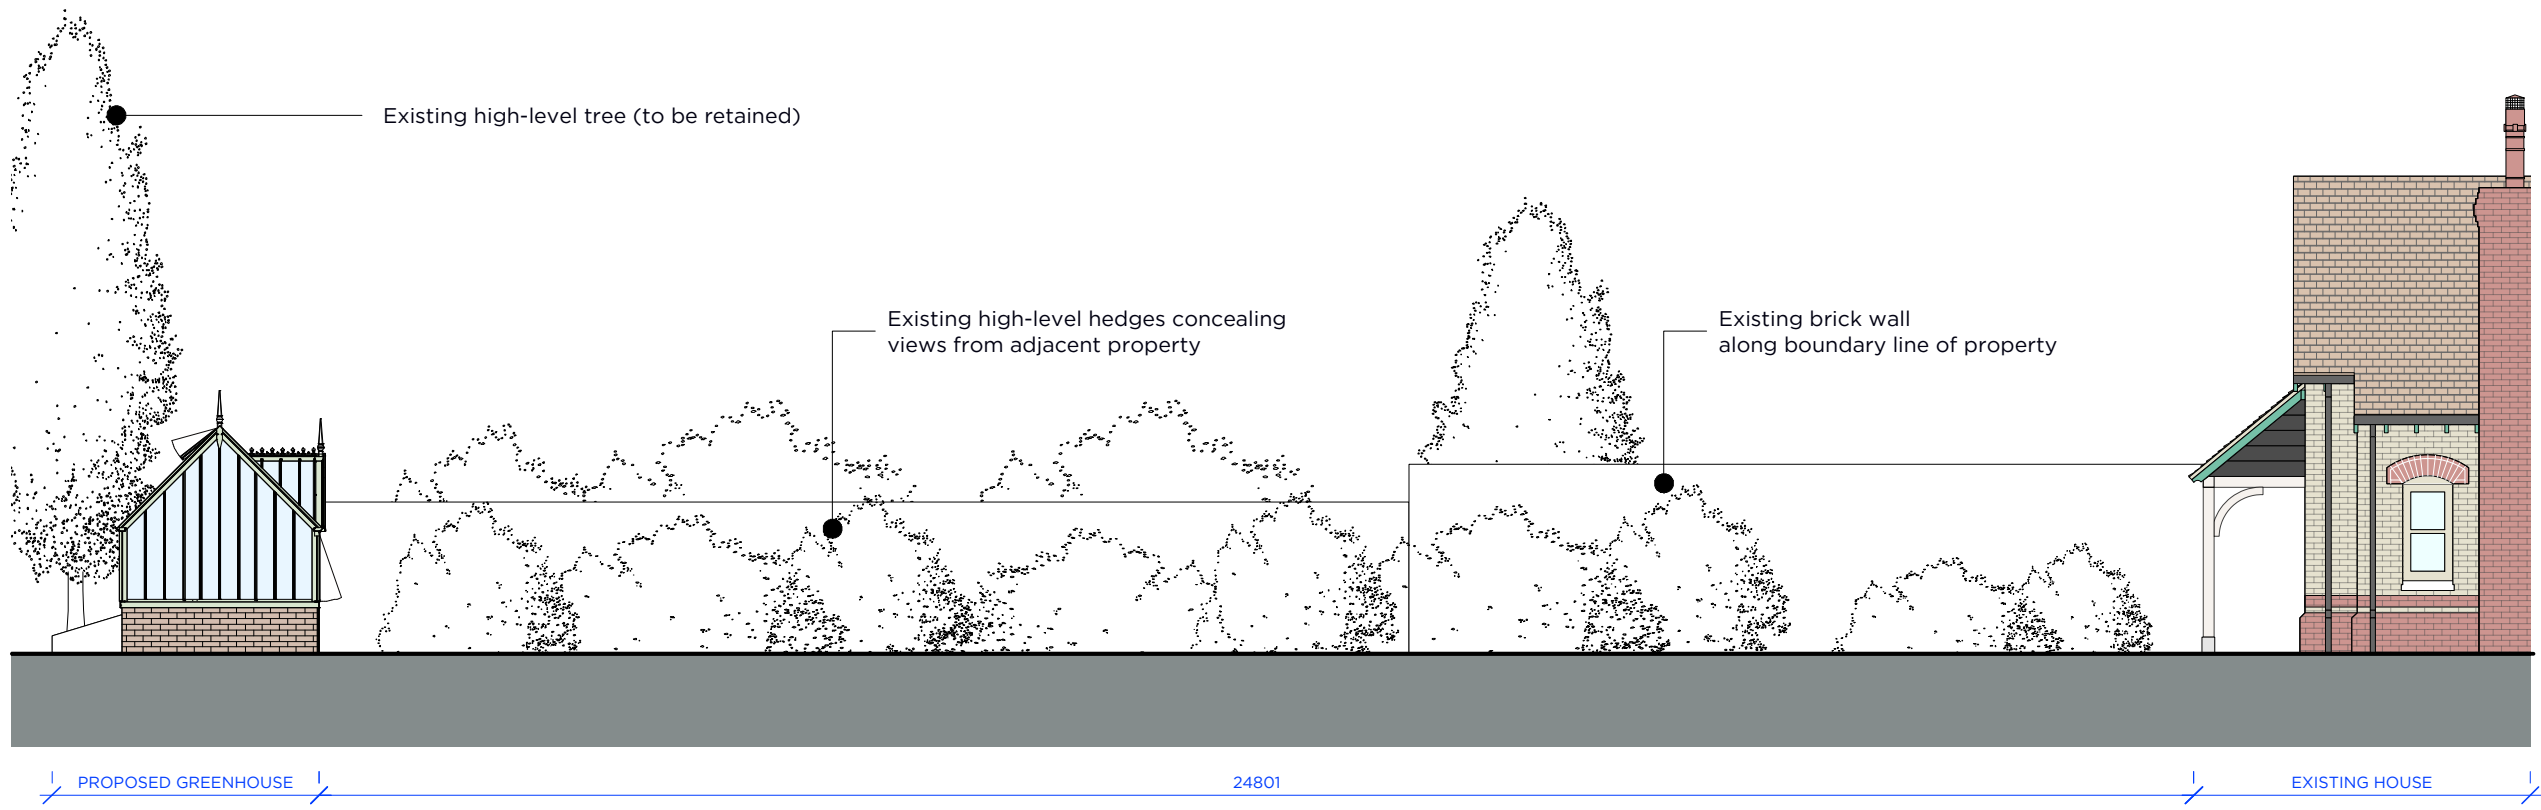

4 Site Context Section AA  
Scale: 1:100

PP	20 07 2020	PLANNING ISSUE	HD
Rev	Date	Amendments	Check

PLANNING ISSUE	
JOB TITLE	GABLE HOUSE, WARREN WOOD MEWS
DRAWING TITLE	GREENHOUSE DRAWINGS
SCALE	1:100 @ A3
DWG NO.	GH001
JOB NO.	205

PROPOSED ELEVATIONS

